

# Landscape Development Requirements & Policies (LDRP)



Please note, the Water Efficient Landscape Ordinance (WELO) has been updated by the Department of Water Resources and has been adopted by the City of Fremont as of December 1, 2015. Please refer to <a href="https://water.ca.gov/Programs/Water-Use-And-Efficiency/Urban-Water-Use-Efficiency/Model-Water-Efficient-Landscape-Ordinance">https://water.ca.gov/Programs/Water-Use-And-Efficiency/Urban-Water-Use-Efficiency/Model-Water-Efficient-Landscape-Ordinance</a> for additional information.

Updated: March 2019 Check on-line for the latest version at: <a href="https://city.fremont.gov/ldrp">https://city.fremont.gov/ldrp</a>



#### FREMONT MUNICIPAL CODE SECTIONS:

FMC 18.215 (Tree Preservation)
FMC 18.235 (Design Review)
FMC 18.215 (Trees)
FMC 18.183.010 (Parking, Loading Areas and Vehicle Storage)
FIRE CODE

And

CITYWIDE DESIGN GUIDELINES (CDG)
NPDES PERMIT SECTION C.3
STATE WATER EFFICIENT LANDSCAPE ORDINANCE (WELO)
BAY FRIENDLY LANDSCAPE GUIDELINES (BFL)
CITY LANDSCAPE STANDARD DETAILS (LSD)



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### **Purpose of LDRP and Definitions**

#### **PURPOSE:**

#### Who uses this document:

The Landscape Development Requirements and Policies (LDRP) is intended for the landscape architect preparing construction documents in the form of Building Permit or Improvement Plans, or in preparing preliminary design documents in the form of a Design Review application for review by the City of Fremont. Some items will require coordination with other disciplines such as civil engineer, planner, arborist or others.

#### What the document does:

The LDRP assembles most of the City of Fremont Council adopted landscape requirements, Regional and State landscape requirements, and Bay-Friendly Landscape requirements (BFL) into one easy to use checklist to assist the applicant/landscape architect when submitting for Building Permit or Improvement Plan approval. The checklist is not required at the time of planning entitlement review (Design Review), but it can assist the design team to develop a plan that will ultimately be subject to these requirements during detailed (construction documents) review. Standalone single-family residential home projects (with less than 500 square feet of landscape area) are not required to complete the checklist unless conditioned through a separate approval.

#### Why should this document be followed:

The primary reason to use this document is to accelerate the Building Permit and Improvement Plan review process so that applicants can move their project through City approval in the most efficient manner possible. Landscape projects that address all the applicable requirements accurately in their first submittal, along with the completed checklist, should be able to gain approval in 2 or 3 reviews (not withstanding other city permit requirements).

In addition to efficient plan reviews, this document can assist the design team to organize and coordinate the multiple landscape requirements and forms set out in the Fremont Municipal Code, State of California Water Efficient Landscape Ordinance (WELO), Municipal Regional National Pollution Discharge Elimination System Permit Provision C.3 (C.3), City Tree Preservation Ordinance, Bay-Friendly Landscape (BFL) practices, Citywide Design Guidelines (CDG) and other outside agency policies.

#### **DEFINITIONS:**

#### **Bay-Friendly Landscape (BFL):**

Bay-Friendly Landscape is a holistic approach to the design and maintenance of landscape to support the integrity of the San Francisco Bay watershed through best practices such as designs that include, but are not limited to, strong harmony with the native and natural conditions, reduced waste, reduced runoff, integrated pest management, improved healthy soils with less fertilizers, and water conservation measures. Fremont encourages all landscapes to achieve this goal, but at a minimum, the three required Bay Friendly practices not included in WELO 2015 must be met. (See Planting section of checklist.) Council adopted the requirement in Resolution 2012-34.



#### WELO:

WELO is the acronym for **Water Efficient Landscape Ordinance**. On December 1, 2015 the State of California revision to WELO became effective for new construction projects with total landscape area equal to or greater than 500 square feet in size and rehabilitated landscape projects with total landscape area of 2,500 square feet or larger. The City of Fremont is required to enforce the State Ordinance through the Building Permit plan review process. WELO establishes many landscape and irrigation water conservation techniques which are included here in this Document. To review the full State Ordinance, visit: <a href="https://water.ca.gov/Programs/Water-Use-And-Efficiency/Urban-Water-Use-Efficiency/Model-Water-Efficient-Landscape-Ordinance">https://water.ca.gov/Programs/Water-Use-And-Efficiency/Urban-Water-Use-Efficiency/Model-Water-Efficient-Landscape-Ordinance</a>

In summary, WELO applies to the following project types that require building permit or improvement plan review and approval:

- a. New construction projects with total landscape area equal to or greater than 500 square feet in size.
- b. Rehabilitated landscape projects with total landscape area of 2,500 square feet or larger.

#### **Tree Survey Requirements:**

The City regulates the removal and destruction of existing trees to preserve the visual beauty that trees provide to the residents and visitors; environmental benefit they provide, such as reducing heat buildup and controlling wind and erosion; and their contribution to property values. Trees have value as individual trees, as groups of trees, and as components of the overall urban forest. To the extent that trees are contributing in these ways to the public welfare of the people of the City of Fremont, trees are protected and preserved through the regulation of their removal and damage to them. The complete Tree Preservation Ordinance is available online at <a href="https://city.fremont.gov/treepreservationordinance">https://city.fremont.gov/treepreservationordinance</a>.

#### Fremont Municipal Code (FMC):

The City Council enacts ordinances that influence and regulate development in Fremont. The citations to the FMC in the checklist are referring to the Zoning code, Tree Preservation code, or Subdivision code. The full Fremont Municipal Code is available for view at: <a href="https://www.fremont.gov/fmc">www.fremont.gov/fmc</a>.

#### **Use of Landscape Standard Details (LSDs):**

The Landscape Standard Details referenced in the LDRP, and included at the end of this package, must be used for City of Fremont projects, on City of Fremont property, and within City of Fremont rights-of-way. These details are not required for private property landscapes, but are available for use.

#### Citywide Design Guidelines (CDG) and other Design Guidelines:

The City Council adopted Citywide Design Guidelines to complement its Design Review permitting process (FMC 18.235). The Citywide Design Guidelines contain both "Rules" and "Guidelines." The Rules are mandatory regulations that must be satisfied when applicable. The Guidelines are used to encourage the highest level of design quality while at the same time providing flexibility necessary to encourage creativity on the part of the project designers. Citations to the citywide and other area specific design guidelines are available online at <a href="https://city.fremont.gov/citywidedesignguidelines">https://city.fremont.gov/citywidedesignguidelines</a>.

#### Municipal Regional National Pollution Discharge Elimination System Permit Provision C.3 (C.3):

The new Municipal Regional National Pollutant Discharge Elimination System Permit (also known as the MRP), issued by the San Francisco Regional Water Quality Control Board, regulates stormwater pollution. The MRP requires 70+ municipalities in the Bay Area, including the City of Fremont, to place conditions on development projects to incorporate site design measures, source controls, treatment measures, and for larger projects, flow duration controls. Permit provision C.3, titled New Development and Redevelopment, gives local responsibility to include low impact development (LID) techniques on projects. The LDRP Checklist is limited to landscape-based LID solutions and coordination of those solutions with other City requirements. The complete City stormwater requirements are available online at <a href="https://city.fremont.gov/stormwaterpermit">https://city.fremont.gov/stormwaterpermit</a>.



# **Items Required with Landscape Plan Submittal**

| D | ELIVERABLES by SUBMITTAL STAGE  | FORMAT   | REFERENCE                |
|---|---|----------|--------------------------|
| Α | . Entitlement (Design Review):  |          |                          |
| 1 | Landscape Plan (Conceptual Planting and Site Plan)  | Plan set | WELO / FMC / BFL         |
| 2 | Preliminary Landscape-based Stormwater Treatment Plan   | Plan set | C.3                      |
| 3 | Tree Survey/Tree Preservation Plan and Tree Species Table   | Plan set | FMC                      |
|   | Building Permit or Improvement Plan Review Construction Documents):  Landscape Plan Checklist (see page 5 of this document)     | 8½ x 11  | City of Fremont required |
|   | ,   |          |                          |
| 2 | Water Efficient Landscape Worksheet   | 8½ x 11  | WELO, See Form A         |
| 3 | Soil Management Report  | 8½ x 11  | WELO                     |
| 4 | Tree Survey/Tree Preservation Plan and Tree Species Table (may be combined with Demolition Plan or Grading Plan as appropriate) | Plan set | FMC                      |
| 5 | Grading Plan (may be prepared by civil engineer).   | Plan set | WELO Section 492.8       |
| 6 | Planting Plan   | Plan set | FMC / WELO Section 492.6 |
| 7 | Hydrozone Plan with Hydrozone Table   | Plan set | WELO, See Form A         |
| 8 | Irrigation Plan   | Plan set | FMC / WELO Section 492.7 |
| 0 | Project Completion (Prior to Construction Sign-off and ccupancy):   | 01/_44   | W5100 0 5 0 5 1          |
| 1 | Certificate of Completion by Property Owner   | 8½ x 11  | WELO, See Form B, Part 1 |
| 2 | Certification of Installation by Landscape Architect - According to the Landscape Documentation Package (WELO)                  | 8½ x 11  | WELO, See Form B, Part 2 |
| 3 | Irrigation Schedule   | 8½ x 11  | WELO, See Form B, Part 2 |
| 4 | Schedule of Landscape and Irrigation Maintenance  | 8½ x 11  | WELO, See Form B, Part 2 |
| 5 | Landscape Irrigation Audit Report (Not required if using Form C)  | 8½ x 11  | WELO, See Form B, Part 2 |



# **Landscape Plan Checklist**

(Submit with Building Permit and/or Improvement Plan Construction Documents)

| Project Name:  |                          |                       |  |  |  |  |  |
|--|--------------------------|-----------------------|--|--|--|--|--|
| PLN" Number (Bldg. Permit) or Tract Number (Improvement Plan): |                          |                       |  |  |  |  |  |
| dscap  | e Arcl                   | hitect &              | & Firm:  |  |  |  |  |
| Licens   | se Nur                   | nber: _               | Phone Number:  |  |  |  |  |
| Subr   | nit the                  | e follov              | ving checklist with First Plan Submittal. Check boxes as they apply.   |  |  |  |  |
| Incomplete   | Not Applicable           |                       |  |  |  |  |  |
|  |                          | A.                    | GENERAL PROJECT AND SUBMITTAL INFORMATION REQUIRED:  |  |  |  |  |
|  |                          | 1.                    | Plans are prepared on accurately surveyed site plan(s) to appropriate scale.   |  |  |  |  |
|  |                          |                       | Reference: FMC 18.235, CDG (Design Development)  |  |  |  |  |
|  |                          | 2.                    | Plans include north arrow, graphic and written scale, property lines, street names, and accurate right of way.   |  |  |  |  |
|  |                          |                       | Reference: FMC 18.235, CDG (Design Development)  |  |  |  |  |
|  |                          | 3.                    | Plans show existing and proposed features.   |  |  |  |  |
|  |                          |                       | <ul> <li>Plans show existing and proposed buildings, trees, structures, walls, fences, utilities, meters, paved areas, and other site improvements.</li> <li>Plans show location of all existing and proposed landscape and streettrees including a complete keyed plant list showing quantities, container sizes, and correct botanical designations of all landscape materials.</li> <li>Plans include design details for landscape architectural features such as walls, fences, lighting, paving types, arbors, benches, fountains and other features; and complete irrigation plans.</li> </ul> References: FMC 18.70.060 and 18.235  |  |  |  |  |
|  | N" Nu dscape Licens Subr | N" Number dscape Arcl | N" Number (Bldg. dscape Architect & License Number: _  Submit the follow  application of the property of the p |  |  |  |  |

**Checklist Legend:** 

LSD:

C.3:



□ □ 4. Plans and calculations are prepared by a Landscape Architect.

**Requirement:** Plans are stamped electronically or otherwise with a valid State of California Landscape Architect's license/stamp including registration number and expiration. Signature required on final set at time of permit issuance.

Reference: FMC 18.205.110. State Business and Professions Code



| Complete | Incomplete | Not Applicable |    |   |
|----------|------------|----------------|----|---|
|          |            |                | В. | SITE LAYOUT REQUIREMENTS:   |
|          |            |                | 1. | Parking lot trees — interior.  Requirement: The plans show one large canopy tree for every 10 parking stalls. Trees shall be evenly distributed throughout the internal field of the parking lot. Large canopy trees can be substituted with medium sized canopy trees if spaced every 6 parking stalls to meet the intent of shading the parking lot.  Note: See LSD-6 and Planting Requirements for definition of "large" and "medium" trees.  Reference: FMC 18.183.110, CDG 3.81G |
|          |            |                | 2. | Parking lot trees — perimeter.  Requirement: The plans show one (1) screen or canopy tree for every three (3) parking stalls between the parking lot and property line, when those stalls are adjacent to the property perimeter.  Reference: FMC 18.183.110, CDG 3.81G   |
|          |            |                | 3. | Parking lot – screening from street.  Requirement: Parking areas within 50 feet of a public street are screened with one of the following:  (CHECK ONE OR MORE):  three (3) foot tall masonry wall, three (3) foot tall berm, or a continuous shrub planting of 5 gallon plants that will grow to a minimum three (3) feet tall.  Note: Downtown and other urban districts and settings may be governed by different requirements.  Reference: FMC 18.183.110                         |
|          |            |                | 4. | Access & circulation, linkages/paving & amenities.  Requirement: Durable decorative paving shall be used at crosswalks within a project and when paved areas serve multiple purposes such as when walks or recreational amenities coincide with driving areas. The path of travel from the street, sidewalk, parking areas and bus stops to the building entrances and key areas within the site shall be easily identifiable.  Reference: CDG 3.7R through 3.11R                     |
|          |            |                | 5. | Minimize hardscape.  Requirement: Minimize hardscape to reduce heat gain and reduce stormwater runoff. Consider use of permeable pavers in areas with good drainage.  Reference: CDG 2.1R, 2.4R   |

**Checklist Legend:** 

LSD: City Landscape Standard Detail WELO: State Water Efficient Landscape Ordinance FMC: Fremont Municipal Code
C.3: NPDES Regional Permit BFL: Qualifies for Bay-Friendly Landscape CDG: Citywide Design Guidelines



|  | 6. | Tree planters – minimum size.  |
|--|----|--|
|  |    | <b>Requirement:</b> Tree planters shall be maximum size feasible to benefit tree growth and provide separation from infrastructure and adjacent paving, curbs, walls, etc. Minimum planter size for trees shall have an interior dimension of six feet in any direction and have no less than 48 square feet of soil surface area overall, which is free of any inorganic material such as utilities, fire hydrants, light poles, signs, subterranean vaults, etc. (hint: an inside planter dimension of 6'x8' is 48 square feet and will fit between two parking stalls.)  Note: Urban tree grate installations are exempt and are governed by LSD-2.  Reference: FMC 18.183.110, CDG 3.77R |
|  | 7. | Play area design complies with the Consumer Product Safety<br>Commission (CPSC) guidelines and American Society for Testing And<br>Materials (ASTM).   |
|  |    | Requirement:  Plans identify safety protection zone(s), Plans identify manufacturer and model numbers Plans include a note requiring contractor to submit a letter prepared by a Certified Playground Inspector certifying that the installed play area is in compliance with ASTM 1487 and CPSC guidelines. The letter shall confirm the manner in which the assembly and installation of playground equipment complies with the requirements.  |
|  | 8. | Pedestrian links between buildings and street provided.  |
|  |    | <b>Requirement:</b> Visually distinct pedestrian walkways shall be provided that link buildings to other buildings, and buildings to street sidewalks. <b>Reference:</b> CDG 3.9R  |
|  | 9. | Wetband firebreak provided adjacent to fire areas.   |
|  |    | <ul> <li>Requirement: For projects in hillside fire areas adjacent to open space or undeveloped land a wetband is required as follows: <ul> <li>A labeled and dimensioned 30-foot wide irrigated or paved protection zone between structure and open space along rear of property.</li> <li>Minimum planting is low growing fire-resistant groundcover or grass.</li> <li>High canopy trees may not be closer than 10 feet to any other mature canopy or structure.</li> <li>Hardscape surfaces and pools may be in Wetband.</li> <li>Large understory shrubs and auxiliary structures are not allowed.</li> </ul> </li> <li>Reference: FMC Fire Code</li> </ul>                             |

**Checklist Legend:** 

LSD: City Landscape Standard Detail NPDES Regional Permit

WELO: State Water Efficient Landscape Ordinance
BFL: Qualifies for Bay-Friendly Landscape

FMC:

CDG:

Fremont Municipal Code

Citywide Design Guidelines



| Complete | Incomplete | Not Applicable |    |   |
|----------|------------|----------------|----|---|
|          |            |                | C. | PLANTING REQUIREMENTS:  |
|          |            |                | 1. | Street trees required.  |
|          |            |                |    | <b>Requirement:</b> Street trees are shown at 24 inch box size and planted within the right of way in front of the each parcel. Street tree placement complies with spacing requirements and distance from utilities as identified in City Standard Detail, LSD-5. Compliance with planting requirements identified in City Standard Details, LSD-1 and LSD-2 is required. <b>Reference:</b> CDG 2.50R, 2.53R, 3.77R, LSD   |
|          |            |                | 2. | Bark mulch required to three inch depth.  |
|          |            |                |    | <b>Requirement:</b> Include a note on plans that three inches of shredded (walk-on) bark mulch is required for all non-sod planting areas. Shredded bark mulch is required in stormwater treatment areas; however, recycled, painted, or dyed mulch is prohibited in stormwater treatment areas. <i>Note: "Gorilla hair" mulch is prohibited. Mulch is not a substitute for landscape planting.</i> <b>Reference:</b> WELO, BFL, LSD  |
|          |            |                | 3. | Compost incorporated at a minimum of four cubic yards per 1,000 square feet.  |
|          |            |                |    | <b>Requirement:</b> Soil amendments shall be incorporated according to recommendations of the soil report. On engineered slopes, only amended planting holes require amendment. Soils with greater than six percent organic matter in the top six inches of soil are exempt from adding compost. <b>Reference:</b> BFL, WELO  |
|          |            |                | 4. | Trees meet minimum spacing from buildings and utilities.  |
|          |            |                |    | <ul> <li>Requirement: Plans show trees with the following minimum clearances to buildings or other built features:</li> <li>Small trees (to 15 feet tall) and columnar trees (to 12' wide) no closer than 6 feet from building or 2 feet from paving, curbs, or walls with a minimum planting area 5 feet wide.</li> <li>Medium trees (to 35 feet tall) no closer than 10 feet from building or 3 feet from paving, curbs, or walls with a minimum planting area 6 feet wide.</li> <li>Large trees (above 35 feet tall) no closer than 15 feet from building or 3 feet from paving, curbs, or walls with a minimum planting area 6 feet wide, preferably 8 feet wide.</li> <li>Refer to City Standard Detail LSD-5 for required spacing from utilities.</li> <li>Reference: LSD, CDG 3.77R</li> </ul> |

**Checklist Legend:** 

LSD: City Landscape Standard Detail WELO: State Water Efficient Landscape Ordinance FMC: Fremont Municipal Code
C.3: NPDES Regional Permit BFL: Qualifies for Bay-Friendly Landscape CDG: Citywide Design Guidelines



| comply with City of Fremont Landscape Standard Details.  Reference: LSD  7. Restrictions on the use of turf.  • Requirement: Turf is limited to no more than 25 percent of the total planted area on the project, as long as the water budget is met.  Note: Use of turf is strongly discouraged to promote water conservation.  Reference: WELO, BFL  • Requirement: Turf is prohibited in medians.  Reference: WELO  • Requirement: Turf is not used on slopes greater than 4:1  Reference: WELO  • Requirement: Plant List (table/legend) shown on plans shall include the Water Use Classificating of Landscape Species (WUCOLS) designation or designation from horticultural researchers with academic or professional associations for the selected species, the spacing for shrub and groundcover species, and the quantity of each plant used.  Note: Use of medium and high water plants is strongly discouraged to promoted water conservation.  Reference: WELO  9. Choose and locate plants to grow to natural size and avoid shearing.  Requirement: No plant species will require shearing. Select species and spacing to allow plant to grow to natural size and shape without shearing at any point in the lifespan of the pla excluding structural and regular maintenance pruning. Plant spacing shall not allow plants to grinto adjacent buildings, sidewalks, roadways, or adjacent landscape areas.  Reference: Bay-Friendly Scorecard item E.1.a, City Council Resolution 2012-34.  |  | 5.  | Plants meet minimum size requirements.   |
|---|--|-----|--|
| Requirement: All landscape work shown in City right of way or City owned property/easements comply with City of Fremont Landscape Standard Details.  Reference: LSD  7. Restrictions on the use of turf.  • Requirement: Turf is limited to no more than 25 percent of the total planted area on the project, as long as the water budget is met.  Note: Use of turf is strongly discouraged to promote water conservation.  Reference: WELO, BFL.  • Requirement: Turf is prohibited in medians.  Reference: WELO  • Requirement: Turf is not used on slopes greater than 4:1  Reference: WELO  On the select water conserving plants and turf species.  Requirement: Plant List (table/legend) shown on plans shall include the Water Use Classificating of Landscape Species (WUCOLS) designation or designation from horticultural researchers with academic or professional associations for the selected species, the spacing for shrub and groundcover species, and the quantity of each plant used.  Note: Use of medium and high water plants is strongly discouraged to promoted water conservation.  Reference: WELO  □ □ 9. Choose and locate plants to grow to natural size and avoid shearing.  Requirement: No plant species will require shearing. Select species and spacing to allow plant to grow to natural size and shape without shearing at any point in the lifespan of the plant species will require shearing. Plant spacing shall not allow plants to grow to natural size and spacing shall not allow plants to grow to nature shearing. Plant spacing shall not allow plants to grow to nature shearing. Plant spacing shall not allow plants to grow to nature shearing. Plant spacing shall not allow plants to grow to nature shearing. Plant spacing shall not allow plants to grow to nature the plants of the plants species listed by CA-IPC as invasive in the San Francisco Bay Area are included in the planting design.   |  |     | <ul> <li>Trees are 15 gallon or larger, except street trees, which are minimum 24 inch box.</li> <li>Shrubs and groundcover plants are minimum 1 gallon size. Forty percent of all shrubs and groundcover must be 5 gallon size or larger.</li> </ul>                |
| comply with City of Fremont Landscape Standard Details.  Reference: LSD  7. Restrictions on the use of turf.  • Requirement: Turf is limited to no more than 25 percent of the total planted area on the project, as long as the water budget is met.  Note: Use of turf is strongly discouraged to promote water conservation.  Reference: WELO, BFL.  • Requirement: Turf is prohibited in medians.  Reference: WELO  • Requirement: Turf is not used on slopes greater than 4:1  Reference: WELO      8. Select water conserving plants and turf species.  Requirement: Plant List (table/legend) shown on plans shall include the Water Use Classification of Landscape Species (WUCOLS) designation or designation from horticultural researchers with academic or professional associations for the selected species, the spacing for shrub and groundcover species, and the quantity of each plant used.  Note: Use of medium and high water plants is strongly discouraged to promoted water conservation.  Reference: WELO  9. Choose and locate plants to grow to natural size and avoid shearing.  Requirement: No plant species will require shearing. Select species and spacing to allow plant to grow to natural size and shape without shearing at any point in the lifespan of the plant of grow to natural size and shape without shearing at any point in the lifespan of the plant of grow to natural size and shape without shearing at any point in the lifespan of the plant of grow to natural size and shape without shearing at any point in the lifespan of the plant of grow to natural size and shape without shearing at any point in the lifespan of the plant of grow to natural size invasive in the San Francisco Bay Area are included in the planting design.   |  | 6.  | City standards for work in right of way or public property.  |
| Requirement: Turf is limited to no more than 25 percent of the total planted area on the project, as long as the water budget is met.  Note: Use of turf is strongly discouraged to promote water conservation.  Reference: WELO, BFL Requirement: Turf is prohibited in medians.  Reference: WELO Requirement: Turf is not used on slopes greater than 4:1  Reference: WELO Requirement: Plant List (table/legend) shown on plans shall include the Water Use Classification of Landscape Species (WUCOLS) designation or designation from horticultural researchers with academic or professional associations for the selected species, the spacing for shrub and groundcover species, and the quantity of each plant used.  Note: Use of medium and high water plants is strongly discouraged to promoted water conservation.  Reference: WELO  9. Choose and locate plants to grow to natural size and avoid shearing.  Requirement: No plant species will require shearing. Select species and spacing to allow plant to grow to natural size and shape without shearing at any point in the lifespan of the plant excluding structural and regular maintenance pruning. Plant spacing shall not allow plants to grow to natural size and shape without shearing at any point in the lifespan of the plant excluding structural and regular maintenance pruning. Plant spacing shall not allow plants to grow to natural size and shape without shearing at any point in the lifespan of the plant excluding structural and regular maintenance pruning. Plant spacing shall not allow plants to grow to natural size and shape without shearing at any point in the lifespan of the plant excluding structural and regular maintenance pruning. Plant spacing shall not allow plants to grow to natural size and shape without shearing at any point in the lifespan of the plant species.  Requirement: None of the plant species listed by CA-IPC as invasive in the San Francisco Bay Area are included in the planting design. |  |     |  |
| project, as long as the water budget is met.  Note: Use of turf is strongly discouraged to promote water conservation.  Reference: WELO, BFL  Requirement: Turf is prohibited in medians. Reference: WELO  Requirement: Plant List (table/legend) shown on plans shall include the Water Use Classification of Landscape Species (WUCOLS) designation or designation from horticultural researchers with academic or professional associations for the selected species, the spacing for shrub and groundcover species, and the quantity of each plant used.  Note: Use of medium and high water plants is strongly discouraged to promoted water conservation. Reference: WELO  Choose and locate plants to grow to natural size and avoid shearing.  Requirement: No plant species will require shearing. Select species and spacing to allow plant to grow to natural size and shape without shearing at any point in the lifespan of the plant excluding structural and regular maintenance pruning. Plant spacing shall not allow plants to grow to adjacent buildings, sidewalks, roadways, or adjacent landscape areas. Reference: Bay-Friendly Scorecard item E.1.a, City Council Resolution 2012-34.  Do not plant invasive plant species. Requirement: None of the plant species listed by CA-IPC as invasive in the San Francisco Bay Area are included in the planting design.  |  | 7.  | Restrictions on the use of turf.   |
| Requirement: Plant List (table/legend) shown on plans shall include the Water Use Classification of Landscape Species (WUCOLS) designation or designation from horticultural researchers with academic or professional associations for the selected species, the spacing for shrub and groundcover species, and the quantity of each plant used.  Note: Use of medium and high water plants is strongly discouraged to promoted water conservation.  Reference: WELO  9. Choose and locate plants to grow to natural size and avoid shearing.  Requirement: No plant species will require shearing. Select species and spacing to allow plant to grow to natural size and shape without shearing at any point in the lifespan of the plant excluding structural and regular maintenance pruning. Plant spacing shall not allow plants to grow to natural size and shape without shearing at any point in the lifespan of the plant adjacent buildings, sidewalks, roadways, or adjacent landscape areas.  Reference: Bay-Friendly Scorecard item E.1.a, City Council Resolution 2012-34.   |  |     | project, as long as the water budget is met.  Note: Use of turf is strongly discouraged to promote water conservation.  Reference: WELO, BFL  Requirement: Turf is prohibited in medians.  Reference: WELO  Requirement: Turf is not used on slopes greater than 4:1 |
| of Landscape Species (WUCOLS) designation or designation from horticultural researchers with academic or professional associations for the selected species, the spacing for shrub and groundcover species, and the quantity of each plant used.  Note: Use of medium and high water plants is strongly discouraged to promoted water conservation.  Reference: WELO  9. Choose and locate plants to grow to natural size and avoid shearing.  Requirement: No plant species will require shearing. Select species and spacing to allow plant to grow to natural size and shape without shearing at any point in the lifespan of the plant excluding structural and regular maintenance pruning. Plant spacing shall not allow plants to grow into adjacent buildings, sidewalks, roadways, or adjacent landscape areas.  Reference: Bay-Friendly Scorecard item E.1.a, City Council Resolution 2012-34.  10. Do not plant invasive plant species.  Requirement: None of the plant species listed by CA-IPC as invasive in the San Francisco Bay Area are included in the planting design.  |  | 8.  | Select water conserving plants and turf species.   |
| Requirement: No plant species will require shearing. Select species and spacing to allow plant to grow to natural size and shape without shearing at any point in the lifespan of the plant excluding structural and regular maintenance pruning. Plant spacing shall not allow plants to grow into adjacent buildings, sidewalks, roadways, or adjacent landscape areas.  Reference: Bay-Friendly Scorecard item E.1.a, City Council Resolution 2012-34.  Do not plant invasive plant species.  Requirement: None of the plant species listed by CA-IPC as invasive in the San Francisco Bay Area are included in the planting design.   |  |     | groundcover species, and the quantity of each plant used.  Note: Use of medium and high water plants is strongly discouraged to promoted water conservation.   |
| to grow to natural size and shape without shearing at any point in the lifespan of the pla excluding structural and regular maintenance pruning. Plant spacing shall not allow plants to grow into adjacent buildings, sidewalks, roadways, or adjacent landscape areas.  Reference: Bay-Friendly Scorecard item E.1.a, City Council Resolution 2012-34.  Do not plant invasive plant species.  Requirement: None of the plant species listed by CA-IPC as invasive in the San Francisco Bay Area are included in the planting design.  |  | 9.  | Choose and locate plants to grow to natural size and avoid shearing.   |
| <b>Requirement:</b> None of the plant species listed by CA-IPC as invasive in the San Francisco Bay Area are included in the planting design.   |  |     |  |
|   |  | 10. | <b>Requirement:</b> None of the plant species listed by CA-IPC as invasive in the San Francisco Bay Area are included in the planting design.  |

**Checklist Legend:** 

LSD: City Landscape Standard Detail WELO: State Water Efficient Landscape Ordinance FMC: Fremont Municipal Code C.3: NPDES Regional Permit BFL: Qualifies for Bay-Friendly Landscape CDG: Citywide Design Guidelines



| Complete | Incomplete | Not Applicable |    |   |
|----------|------------|----------------|----|---|
|          |            |                | D. | TREE PRESERVATION REQUIREMENTS [FMC 18.215.120]   |
|          |            |                | 1. | Tree survey meets minimum plan standards.   |
|          |            |                |    | <ul> <li>Existing and proposed site features, including but not limited to buildings, walls, paving, grading, etc.</li> <li>Tree(s) with six inch DBH (trunk diameter at 4.5 feet above ground level) and larger are located on plan by a licensed surveyor. Tree trunks must be represented with an accurately scaled dot to show the true bulk of the DBH. Tree canopies must be accurately delineated.</li> <li>Trees are labeled by number on the plan and tagged on-site per ISA standards.</li> <li>Tree Survey Plan includes a summary table identifying botanical designation, DBH, and elevation of each tree at ground level.</li> <li>Note: Tree Survey information may be incorporated into a topographic survey or other project plan, provided all the required information is included. If no trees exist on site, provide a statement by the civil engineer, landscape architect or surveyor indicating this, in lieu of the required tree survey.</li> <li>Reference: FMC 18.215.120</li> <li>Sample Plan: See the sample Tree Survey on page 24.</li> </ul> |
|          |            |                | 2. | Tree survey is incorporated into other plans.  Project plans clearly show which trees are proposed for preservation and which trees are proposed for removal. Trees for removal and preservation are shown on ALL the following project (construction) plans:  • Show trees for removal and preservation on the following plans:  • Grading Plan  • Demolition Plan  • Show trees for preservation (only) on the following plans:  • Planting Plan  • Irrigation Plan  • Underground Utility Plans and Joint Trench Plan  |
|          |            |                | 3. | Tree protection fencing shown on plans.  Requirement: Trees designated for preservation comply with City of Fremont Standard Detail: "Tree Protection Fencing," LSD-9, or other tree specific City approved tree protection measures prepared by a International Society of Arboriculture (ISA) Certified Arborist or American Society of Consulting Arborist (ASCA) member in good standing.  Reference: LSD   |

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C.3: NPDES Regional Permit BFL: Qualifies for Bay-Friendly Landscape CDG: Citywide Design Guidelines



Not Applicable ncomplete E. **IRRIGATION REQUIREMENTS:** 1. П Meters and valves. Requirement: Plans show location and size of all meters and submeters, points of connection, pumps, isolation valves and remote control valves. Irrigation must be on a dedicated meter or submeter for non-residential projects 1,000 square feet and greater and residential projects 5,000 square feet and greater. Reference: WELO 2. Master shut-off valves. Requirement: Plans show locations and types of all master shut-off valves. Landscapes that make use of technologies that allow for the individual control of sprinklers that are individually pressurized in a system equipped with low pressure shut down features are excepted. Reference: WELO 3. Flow sensors. Requirement: Plans show flow sensors that detect high flow conditions created by system damage for all non-residential landscapes and residential landscapes of 5,000 square feet and larger. Reference: WELO Operating pressure and GPM. 4. Requirement: Maximum GPM (Gallons Per Minute) demand and minimum operating pressure for each point of connection is clearly shown on plan along with the GPM demand for each valve. If the water pressure is below or exceeds the recommended pressure of the specified devices, the installation of a pressure regulating device is required. Reference: WELO, BFL 5. Pipes and sleeves.

**Requirement:** Plans show size and location of all pipes including sleeves for the irrigation system The following minimum requirements are shown on the plans:

All lateral lines shall have 12" cover.

□ All main lines shall have 18" cover.

□ All main lines and wiring under pavement shall be sleeved with 24" cover.

All lateral lines under pavement shall be sleeved with 18" cover.


#### **Checklist Legend:**



| Complete | Incomplete | Not Applicable |     |   |
|----------|------------|----------------|-----|---|
|          |            |                | 6.  | Hose bibs and quick couplers.   |
|          |            |                |     | <b>Requirement:</b> Plans show location and type of all hose bibs and quick couplers. <b>Reference:</b> WELO  |
|          |            |                | 7.  | Weather-based controller.   |
|          |            |                |     | <b>Requirement:</b> Plans show location and type of weather-based controller, which relies on soil moisture sensor, rain gauge or other weather-based controlling device. <b>Reference:</b> WELO, BFL   |
|          |            |                | 8.  | Backflow prevention device.   |
|          |            |                |     | <b>Requirement:</b> A Reduced Pressure Backflow Prevention Device (with enclosure) of the same size as the meter shall be installed at every irrigation meter on the project. The model and installation of the Backflow Prevention Unit is subject to approval from the Alameda County Water District. A weather blanket shall be installed on all backflow prevention devices. Use LSD-16 and LSD-17 for irrigation on City of Fremont property and rights-of-way. <b>Reference:</b> WELO |
|          |            |                | 9.  | Design details included.  |
|          |            |                |     | <b>Requirement:</b> Irrigation installation details shall be shown on plans to demonstrate compliance with these irrigation requirements. Use City of Fremont irrigation Landscape Standard Details (LSDs) for areas on City property or rights-of-way.   |
|          |            |                | 10. | All irrigation equipment must meet ANSI and ASABE/ICC802-2014 standards.  |
|          |            |                |     | <b>Requirement:</b> All irrigation equipment must meet American National Standards Institute (ANSI), American Society of Agricultural and Biological Engineers/ International Code Council (ASABE/ICC)802-2014. "Landscape Irrigation Sprinkler and Emitter Standard. All sprinkler heads installed in the landscape must document a distribution uniformity low quarter of .65 or higher using the protocol defined in ASABE/ICC 802-2014. <b>Reference:</b> WELO                          |
|          |            |                | 11. | Irrigate trees separately.  |
|          |            |                |     | <b>Requirement:</b> All trees are irrigated by individual bubblers on an irrigation circuit isolated from the main system by a remote control valve. <b>Reference:</b> WELO   |

**Checklist Legend:** 

LSD: City Landscape Standard Detail WELO: State Water Efficient Landscape Ordinance FMC: Fremont Municipal Code
C.3: NPDES Regional Permit BFL: Qualifies for Bay-Friendly Landscape CDG: Citywide Design Guidelines

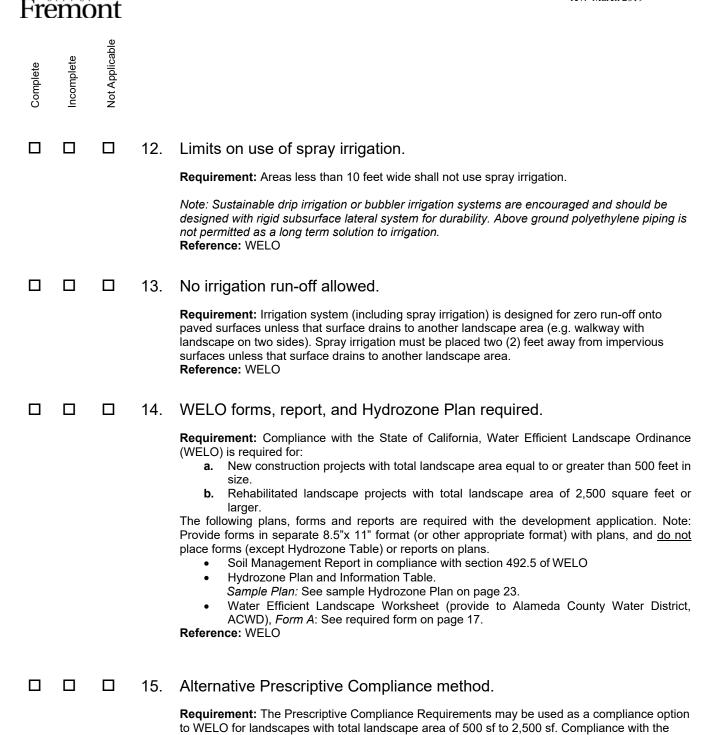

**Checklist Legend:** 

Reference: WELO

LSD: City Landscape Standard Detail WELO: State Water Efficient Landscape Ordinance FMC: Fremont Municipal Code
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entire list, Form C, is mandatory and must be documented on a landscape plan in order to use the prescriptive compliance option. Submit completed Form C with landscape plan. Pages 21-22.



|  | 16. | Separated irrigation system required for City property, easements, and Homeowner Association managed common areas.  |
|--|-----|---|
|  |     | <b>Requirement:</b> Back-up landscape or any landscape that will be maintained or owned by the City has a separate meter, backflow prevention device and controller compliant with City Standard Details. <b>Reference:</b> WELO, LSD   |
|  | 17. | Include a note on the plans requiring submittal of the Certificates of Completion and Installation and all related documents (Irrigation Scheduling, Schedule of Landscape and Irrigation Maintenance, Landscape Irrigation Audit Report, and Soil Management Report) upor completion of construction, prior to project acceptance.   |
|  |     | <b>Requirement:</b> Completion and installation of WELO-compliant landscape and irrigation must be documented via the WELO/LDRP forms. Forms must be signed by the property owner, landscape contractor, and the project landscape architect. Forms are described below. <b>Reference:</b> WELO, LSD  |
|  | 18. | Post construction signoff by project landscape architect and owner.   |
|  |     | Requirement: The following documents and certifications are required before final occupance from the Building Official during construction to comply with WELO. Provide forms in separate 8.5" by 11" format (or other appropriate format) with plans. Do not place forms on plans.  Note: The Project Landscape Architect should anticipate inspection during construction to support separate written certifications from him or her, that the installed and completed project complies with the City of Fremont Approved Plans, and complies with the WELO requirements as documented in the plans.  • Certificate of Completion signed by property owner,  Form B, Part 1: See required form, page 19.  • Certificate of Installation signed by the Project Landscape Architect, AND the Project (Licensed) Landscape Contractor.  Form B, Part 2: See required form, page 20.  • Irrigation Scheduling  Form B, Part 3: See required attachment, page 20.  • Schedule of Landscape and Irrigation Maintenance,  Form B, Part 4: See required attachment, page 20.  • Landscape Irrigation Audit Report,  Form B, Part 5: See required attachment, page 20.  • Soil Management Report,  Form B, Part 6: See required attachment, page 20.  • Prescriptive Compliance Checklist,  Form C: See required form, pages 21-22.  Form B, Parts 1, 2, 3, 4, and 6: See required forms, pages 19-20. |

**Checklist Legend:** 

LSD: City Landscape Standard DetailC.3: NPDES Regional Permit

WELO: BFL:

Reference: WELO

State Water Efficient Landscape Ordinance Qualifies for Bay-Friendly Landscape

FMC: CDG:

Fremont Municipal Code Citywide Design Guidelines



Complete Incomplete Not Applicable

| Ö | <u>lu</u> o | Not |    |  |
|---|-------------|-----|----|--|
|   |             |     | F. | STORMWATER (LANDSCAPE-BASED) REQUIREMENTS:   |
|   |             |     | 1. | Design of landscape-based stormwater treatment complies with City Standards.   |
|   |             |     |    | <b>Requirement:</b> The design of stormwater treatment in the right of way complies with City Landscape Standard Details and the Municipal Regional National Pollution Discharge Elimination System Permit Provision C.3 requirements. The City details show options that include a tree well filter and a stormwater planter for use in the right of way. Trash Capture Devices are required upstream of planter with treatment soil in the right of way. |
|   |             |     |    | Note: The handbook is available on the Alameda Countywide Clean Water Program website at: <a href="http://www.cleanwaterprogram.org/businesses">http://www.cleanwaterprogram.org/businesses</a> developers.htm, and City of Fremont Stormwater requirements at <a href="https://city.fremont.gov/stormwaterpermit">https://city.fremont.gov/stormwaterpermit</a> .  Reference: LSD, C.3  |
|   |             |     | 2  | Plans show specifications for treatment soil.  |
|   |             |     |    | <b>Requirement:</b> Plans show soil specifications in compliance with the Alameda Countywide Clean Water Program C.3 Technical Guide when treatment soil is used on projects. <b>Reference:</b> C.3, BFL   |
|   |             |     | 3. | Plans delineate treatment areas.   |
|   |             |     |    | <b>Requirement:</b> Plans clearly delineate where landscape based stormwater design features are located throughout the site. Place curb or header around landscape-based stormwater features for easy identification when combined with or adjacent to non-stormwater landscape. <b>Reference:</b> C.3  |

### ~ End of Landscape Plan Checklist ~

#### **Checklist Legend:**



# LDRP Form A: Water Efficient Landscape Worksheet

| This form is equivalent to the MVVELO Appendix B Workshe | et and must be submitted with the Landscape Documentation Package. |
|--|--|
| Project Name:  | PLN #:   |

| Reference Ev   | apotranspir          | ation (ETo)                       |   | ı               |                             |             |   |
|--|----------------------|-----------------------------------|---|-----------------|-----------------------------|-------------|---|
| Hydrozone #<br>/Planting<br>Description <sup>a</sup> | Plant<br>Factor (PF) | Irrigation<br>Method <sup>b</sup> | Irrigation<br>Efficiency<br>(IE) <sup>c</sup> | ETAF<br>(PF/IE) | Landscape<br>Area (sq, ft,) | ETAF x Area | Estimated Total<br>Water Use<br>(ETWU)° |
| Regular Landscap                                     | e Areas              |                                   |   |                 |                             |             |   |
|  |                      |                                   |   |                 |                             |             |   |
|  |                      |                                   |   |                 |                             |             |   |
|  |                      |                                   |   |                 |                             |             |   |
|  |                      |                                   |   |                 |                             |             |   |
|  |                      |                                   |   | Totals          | (A)                         | (B)         |   |
| Special Landscap                                     | e Areas              |                                   |   |                 |                             |             |   |
|  |                      |                                   |   | 1               |                             |             |   |
|  |                      |                                   |   | 1               |                             |             |   |
|  |                      |                                   |   | 1               |                             |             |   |
|  |                      |                                   |   | Totals          | (C)                         | (D)         |   |
|  |                      |                                   |   | •               |                             | ETWU Total  |   |

<sup>a</sup>Hydrozone #/Planting Description

E.g

1.) front lawn

- 2.) low water use plantings
- 3.) medium water use planting

<sup>b</sup>Irrigation Method overhead spray or drip

<sup>c</sup>Irrigation Efficiency 0.75 for spray head 0.81 for drip

Maximum Allowed Water Allowance (MAWA)e

<sup>d</sup>ETWU (Annual Gallons Required) = Eto x 0.62 x ETAF x Area

where 0.62 is a conversion factor that converts acre-inches per acre per year to gallons per square foot per year.

#### $^{e}$ MAWA (Annual Gallons Allowed) = (Eto) (0.62) [ (ETAF x LA) + ((1-ETAF) x SLA)]

where 0.62 is a conversion factor that converts acre-inches per acre per year to gallons per square foot per year, LA is the total landscape area in square feet, SLA is the total special landscape area in square feet, and ETAF is 0.55 for residential areas and 0.45 for non-residential areas.

#### **ETAF Calculations**

#### Regular Landscape Areas

| Total ETAF x Area | (B) |
|-------------------|-----|
| Total Area        | (A) |
| Average ETAF      | B÷A |

#### All Landscape Areas

| Total ETAF x Area | (B+D)         |
|-------------------|---------------|
| Total Area        | (A+C)         |
| Sitewide ETAF     | (B+D) ÷ (A+C) |

Average ETAF for Regular Landscape Areas must be 0.55 or below for residential areas, and 0.45 or below for non-residential areas.





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# LDRP Form B, Part 1: Certificate of Completion This certificate is equivalent to the MWELO Appendix C (Part 1) certificate and is to be filled out by the project applicant upon completion of the landscape project.

| Project Name:  |   |   |                | PLN #:                 |
|--|---|---|----------------|------------------------|
| DART 4 F   | DO IECT INCODMA                         | ATION CHEET   |                |                        |
| Date   | ROJECT INFORMA                          | TION SHEET  |                |                        |
| Project Name   |   |   |                |                        |
| Name of Project Applicar   | nt                                      | Telephone No.   |                |                        |
|  |   | Fax No.   |                |                        |
| Title  |   | Email Address   |                |                        |
| Company  |   | Street Address  |                |                        |
| City   |   | State   |                | Zip Code               |
|  |   |   |                |                        |
| Project Address Street Address                                   | and Location:                           | Parcel, tract or lot number,  | , if available | e.                     |
| City   |   | Latitude/Longitude (option  | al)            |                        |
| State  | Zip Code                                |   | ,              |                        |
|  |   |   |                |                        |
| Property Owner   | or his/her designe                      | <b>e:</b>   |                |                        |
| Name   |   | Telephone No.   |                |                        |
|  |   | Fax No.   |                |                        |
| Title  |   | Email Address   |                |                        |
| Company  |   | Street Address  |                |                        |
| City   |   | State   |                | Zip Code               |
| Package and the Ce   | ertificate of Completion                | of all the documents within<br>and that it is our responsib<br>ape and Irrigation Maintena              | oility to se   | ee that the project is |
| Property Owner Sign  | nature                                  |   | [              | Date                   |
| <ul><li>2. Date the Landso</li><li>3. Date that a copy</li></ul> | cape Documentation Page Documentation P | ackage was submitted to th<br>ackage was approved by th<br>Landscape Worksheet (ind<br>I water purveyor | he local a     | agency                 |



# LDRP Form B, Part 2: Certificate of Installation According to the Landscape Documentation Package

This certificate is equivalent to the second page of the MWELO Appendix C (Part 2) certificate and is to be filled out by the project applicant upon completion of the landscape project.

# PART 2. CERTIFICATION OF INSTALLATION ACCORDING TO THE LANDSCAPE DOCUMENTATION PACKAGE

"I/we certify that based upon periodic site observations, the work has been substantially completed in accordance with the ordinance and that the landscape planting and irrigation installation conform with the criteria and specifications of the approved Landscape Documentation Package."

| Signature of Landscape Contractor: | Date            |          |
|------------------------------------|-----------------|----------|
|                                    |                 |          |
|                                    |                 |          |
| Name (print)                       | Telephone No.   |          |
|                                    |                 |          |
| Title                              | Email Address   |          |
| License No. or Certification No.   |                 |          |
|                                    |                 |          |
| Company                            | Street Address  |          |
|                                    |                 |          |
| City                               | State           | Zip Code |
|                                    |                 |          |
|                                    |                 |          |
| Signature of Landscape Architect:  | Date            |          |
| Signature of Landscape Architect.  | Date            |          |
|                                    |                 |          |
|                                    |                 |          |
| Name (print)                       | Telephone No.   |          |
| Title                              | Email Address   |          |
|                                    |                 |          |
| License No.                        |                 |          |
| Company                            | Street Address  |          |
| o simpany                          | 3.337, Iddi 333 |          |
|                                    |                 |          |
| City                               | State           | Zip Code |
|                                    |                 |          |

#### **PART 3. IRRIGATION SCHEDULING**

Attach parameters for setting the irrigation schedule on controller per ordinance Section 492.10.

#### PART 4. SCHEDULE OF LANDSCAPE AND IRRIGATION MAINTENANCE

Attach schedule of Landscape and Irrigation Maintenance per ordinance Section 492.11.

#### PART 5. LANDSCAPE IRRIGATION AUDIT REPORT

Attach Landscape Irrigation Audit Report per ordinance Section 492.12.

#### **PART 6. SOIL MANAGEMENT REPORT**

Attach soil analysis report, if not previously submitted with the Landscape Documentation Package per ordinance Section 492.6.

Attach documentation verifying implementation of recommendations from soil analysis report per ordinance Section 492.6.



LDRP Form C: Prescriptive Compliance Option

For Landscape projects that are 500 to 2,500 square feet, the following Prescriptive Compliance Option may be used. If selected, compliance with the following items is mandatory and must be documented on a landscape plan. At the time of final inspection, the permit applicant must provide the City and the owner of the property with a certificate of completion, certificate of installation, irrigation schedule and a schedule of landscape and irrigation maintenance.


| Pro      | oject N    | Name:  | PLN #:                                     |
|----------|------------|--|--|
| Complete | Incomplete | Submit a Landscape Documentation Package which inc         | ludes the following elements:              |
|          |            | A. date  |  |
|          |            | B. project applicant                                       |  |
|          |            | C. project address (if available, parcel and/or lot numbe  | er(s))                                     |
|          |            |  |  |
|          |            |  |  |
|          |            | F. water supply type (e.g., potable, recycled, well) and i | dentify the local retail water purveyor    |
|          |            | if the applicant is not served by a private well           |  |
|          |            | G. contact information for the project applicant and prop  | perty owner                                |
|          |            | H. applicant signature and date with statement, "I agree   | to comply with the requirements of         |
|          |            | the prescriptive compliance option of the MWELO.           | "  |
|          |            | Incorporate compost at a rate of at least four cubic yards | s per 1,000 square feet to a depth of      |
|          |            | six (6) inches into landscape area (unless contra-in       | ndicated by a soil test).                  |
|          |            | 3. Plant material shall comply with all of the following:  |  |
|          |            | A. For residential areas, install climate adapted and nati | ive plants that require occasional, little |
|          |            | or no summer water (average WUCOLS plant fact              | or 0.3) for seventy five percent (75%)     |
|          |            | of the plant area excluding edibles and areas using        | g recycled water; For non-residential      |
|          |            | areas, install climate adapted and native plants tha       | at require occasional, little or no        |
|          |            | summer water (average WUCOLS plant factor 0.3              | ) for 100% of the plant area excluding     |
|          |            | edibles and areas using recycled water;                    |  |
|          |            | B. A minimum three inch (3") layer of mulch shall be ap    | plied on all exposed soil surfaces of      |
|          |            | planting areas except in turf areas, creeping or roc       | oting groundcovers, or direct seeding      |
|          |            | applications where mulch is contraindicated.               |  |
|          |            | 4. Turf shall comply with all of the following:            |  |
|          |            | A. Turf shall not exceed twenty five percent (25%) of the  | e landscape area in residential areas,     |
|          |            | and there shall be no turf in non-residential areas;       |  |






| Complete | Incomplet |   |
|----------|-----------|---|
|          |           | B. Turf shall not be planted on sloped areas which exceed twenty five percent (25%), a slope of one (1) foot vertical elevation change for every four (4) feetof horizontal length; and   |
|          |           | C. Turf is prohibited in parkways less than ten feet (10') wide, unless the parkway is adjacent<br>to a parking strip and used to enter and exit vehicles. Any turf in parkways must be<br>irrigated by sub-surface irrigation or by other technology that creates no overspray or<br>runoff.                                     |
|          |           | 5. Irrigation systems shall comply with the following:  |
|          |           | A. Automatic irrigation controllers are required and must use evapotranspiration or soil moisture sensor data and utilize a rain sensor.  |
|          |           | B. Irrigation controllers shall be of a type which does not lose programming data in the event the primary power source is interrupted.   |
|          |           | C. Pressure regulators shall be installed on the irrigation system to ensure the dynamic pressure of the system is within the manufacturer's recommended pressure range.  |
|          |           | D. Manual shut-off valves (such as a gate valve, ball valve, or butterfly valve) shall be installed as close as possible to the point of connection of the water supply.  |
|          |           | E. All irrigation equipment must meet the requirements set in the ANSI standard, ASABE/ICC 802-2014. "Landscape Irrigation Sprinkler and Emitter Standard," All sprinkler heads installed in the landscape must document a distribution uniformitylow quarter of 0.65 or higher using the protocol defined in ASABE/ICC 802-2014. |
|          |           | F. Areas less than ten feet (10') in width in any direction shall be irrigated with subsurface irrigation or other means that produce no runoff or overspray.   |
|          |           | 6. For non-residential projects with landscape areas of 1,000 square feet or more, aprivate submeter(s) to measure landscape water use shall be installed.  |
|          |           | 7. Alameda County law prohibits disposal of plant debris in county landfills. ACWMA Plant Debris Landfill Ban Ordinance 2008-01 requires landscape professionals, to separate all plant debris from garbage. http://www.recyclingrulesac.org/docs/Landfill-Ban-WMA-Ordinance2008-01.pdf   |



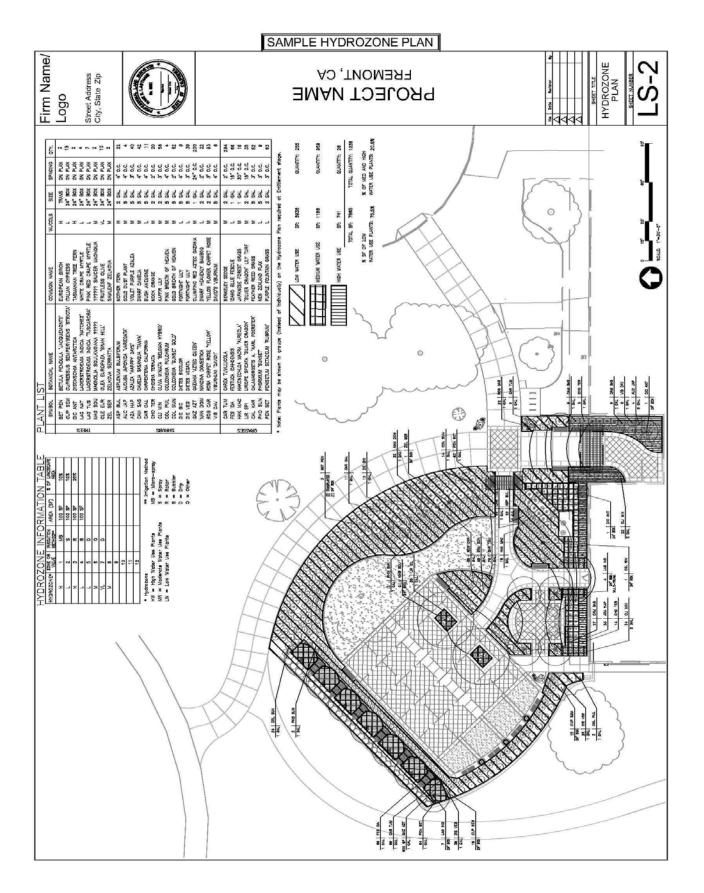



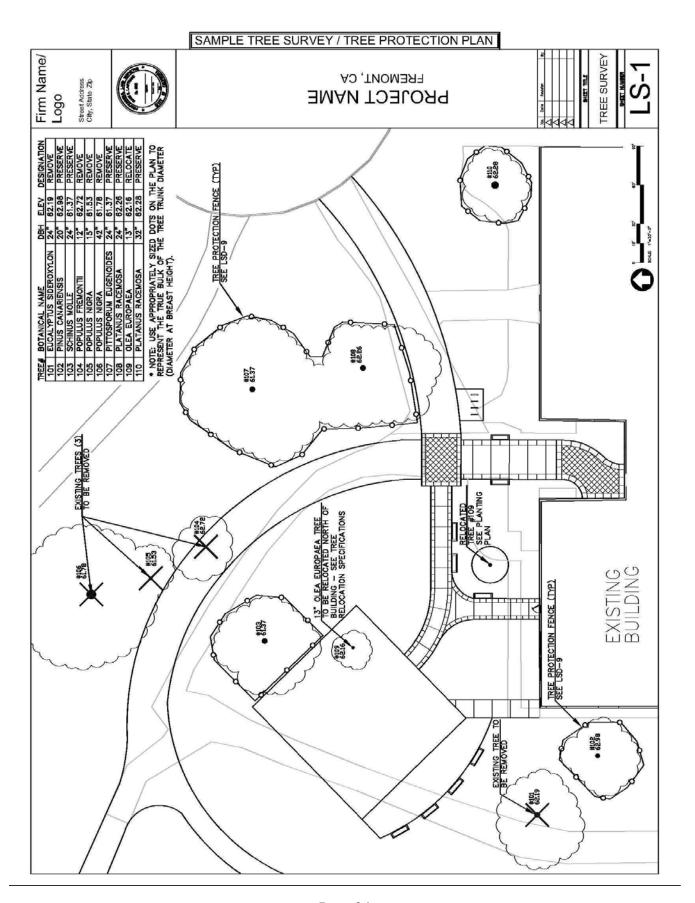



# Requesting Landscape Inspection of Development <u>Projects</u>

Construction must be 100% complete before requesting inspection for Building Permit (occupancy) or Tract Acceptance. All post construction forms must be completed and submitted to the City with the inspection request.

#### Forms required:

- Form B, Part 1: Certificate of Completion (WELO)
- Form B, Part 2: Certificate of Installation (WELO), with following attachments:
- Form B, Part 3: Irrigation Scheduling
- Form B, Part 4: Schedule of Landscape and Irrigation Maintenance
- Form B, Part 5: Landscape Irrigation Audit Report (conducted by a Certified landscape Irrigation Auditor)
- Form B, Part 6: Soil Management Report (Include verification of implementation of recommendations from soil analysis report)

#### For Tract Acceptance:

\*Note: Only 15% of production homes require irrigation audit.

Engineering Construction Inspection Public Works Department 39550 Liberty Street Fremont, CA 93537-5006 Ph: (510) 494-4700

Fax: (510) 494-4646

#### For Certificate of Occupancy:

Development Services Technician Community Development Department 39550 Liberty Street Fremont, CA 93537-5005

Ph: (510) 494-4480 Fax: (510) 494-4820

Special note for Temporary Occupancy Requests: Temporary Occupancies are handled on a case-by-case basis. At a minimum, landscape must be substantially complete with only minor items remaining. In cases where Temporary Occupancies are considered by the City, the Certificate of Completion (Form B, Part 1) and the Certificate of Installation (Form B, Part 2) may be temporarily substituted for a detailed punch-list prepared by the Project Landscape Architect. The punch list shall document all minor items remaining that must be completed before Final Occupancy. Certificate of Completion (Form B, Part 1) and the Certificate of Installation (Form B, Part 2) and follow-up City inspection is still required before Final Occupancy.

#### **Miscellaneous Landscape Inspection Requests:**

City Landscape Architect Community Services Department 39550 Liberty Street Fremont, CA 94537-5006 Ph: (510) 494-4700

Fax: (510) 494-4721



## **Arborist Analysis Report Standards**

Note: Arborist analysis is only required if requested by the city and is not a standard submittal item on development projects or as part of a Tree Removal Application. The applicant may choose to provide an arborist analysis at his or her discretion, in advance of a potential request by the city.

An arborist analysis report is required to make a more detailed assessment of an individual tree's suitability for preservation or assessment of a proposed design near an existing tree. The report shall be prepared by an Arborist, certified by the ISA (International Society of Arboriculture) and approved by the City of Fremont. The City will require a deposit (estimated amount) from the applicant in order to cover the cost of the arborist report. If the applicant uses their own approved Arborist, the deposit may be required for a peer review of the Arborist report. Any unused amount of the deposit will be returned to the applicant.

The arborist report will include, at a minimum, the following factors in the evaluation of suitability for preservation:

#### \*Tree health

Healthy, vigorous trees are better able to tolerate impacts such as root injury, demolition of existing structures, changes in soil grade and moisture, and soil compaction, than are non-vigorous trees.

#### \*Structural Integrity

Trees with significant amounts of wood decay and other structural defects that cannot be corrected are likely to fail. Such trees will not be preserved in areas where damage to people or property is likely to occur.

#### \*Species response

There is a wide variation in the response of individual species to construction impacts and changes in the environment.

#### \*Tree age and longevity

Old trees, while having significant emotional and aesthetic appeal, sometimes have limited physiological capacity to adjust to an altered environment. Young trees are better able to generate new tissue and respond to change. Older trees may require modifications to the development proposal, to achieve preservation.

#### \*Other evaluation as identified by the City

Each project has unique features that may impact trees. The analysis will explore innovative alternatives in design that promote preservation of quality trees. The City may choose to require tree appraisals on complex projects where significant development may occur near trees to be preserved. Tree appraisals will provide a basis of penalties for destruction of trees during construction and may be used to assess mitigation on projects with significant tree removal.

Give each tree a rating for suitability for preservation based upon its age, health, structural condition, and tree's ability to exist safely within the development environment.





#### TREE PERMIT & **APPLICATION**

#### INSTRUCTIONS

- Complete all fields of this form as incomplete applications will delay request.
   A fee is not required.

|      | Tree Pe  | rmit #:  |   |
|------|----------|----------|---|
|      | ×        | _=_      |   |
| (For | r Office | Use Only | ) |

| Submit completed application to <u>treepermits@freme</u> For inquiries, please call the tree permit line at (510)   |  |   | (For Office Use Only)  |
|---|--|---|--|
| APPLICATION DATE:/  | A COLUMN TO COLUMN   | ithout City approv                        | ed signature and date stamp  |
| PERMIT TYPE:  |  |   | V III A STATE OF THE STATE OF T |
| TREET TREE: Select one of the following:  | ☐ Planting Permit  | ☐ Pruning Pe                              | ermit  |
| Note: Leave this section blank if not street tree.  | Removal Permit   | ☐ Root Pruni                              | ng Permit  |
| PRIVATE PROTECTED TREE: Note: Leave this section blank if not a private tree.   | Removal Permit   |   | 3  |
| OWNER INFORMATION:<br>Required for all applicants   |  | ONTRACTOR IN                              |  |
| NAME: STREET ADDRESS:   |  |   |  |
| ZIPCODE: "ELEPHONE #: :MAIL ADDRESS:  |  |   |  |
| PREFERRED REPLACEMENT TREE(S):  |  |   | QUANTITY:  |
| Replacement tree required.  |  |   |  |
| REASON FOR REMOVAL: Please attach picture with application.   |  |   |  |
| Please attach picture with application.  dditional Requirements: All stumps must be groun om the date of approval (see expiration date bel  | low). Install trees per City   | nt depth minimum. 1<br>Standard Detail LS | This permit expires in 6 month:<br>SD-1. All pruning must be pe  |
| Please attach picture with application.  Idditional Requirements: All stumps must be groun from the date of approval (see expiration date bel alternational Society of Arboriculture (ISA) standards  | low). Install trees per City   | Standard Detail LS                        | 6D-1. All pruning must be pe   |
| Please attach picture with application.  Additional Requirements: All stumps must be groun from the date of approval (see expiration date bel niternational Society of Arboriculture (ISA) standards  SECTION   | low). Install trees per City<br>s or ANSI 300.   | Standard Detail LS                        | This permit expires in 6 month:<br>SD-1. All pruning must be pe<br>Date Stamp:   |
| Please attach picture with application.  dditional Requirements: All stumps must be groun om the date of approval (see expiration date bel atternational Society of Arboriculture (ISA) standards   | low). Install trees per City<br>s or ANSI 300.<br>TO BE FILLED OUT BY CITY.<br>REQUIRED MITIGATION | Standard Detail LS                        | 6D-1. All pruning must be pe   |
| Please attach picture with application.  Idditional Requirements: All stumps must be ground the date of approval (see expiration date beinternational Society of Arboriculture (ISA) standards  SECTION  To appeal a permit denial before the City Council, contact the   | low). Install trees per City<br>s or ANSI 300.<br>TO BE FILLED OUT BY CITY.<br>REQUIRED MITIGATION | Standard Detail LS                        | 6D-1. All pruning must be pe   |
| Please attach picture with application.  Additional Requirements: All stumps must be groun from the date of approval (see expiration date beinternational Society of Arboriculture (ISA) standards  SECTION  To appeal a permit denial before the City  Species:  | low). Install trees per City<br>s or ANSI 300.<br>TO BE FILLED OUT BY CITY.<br>REQUIRED MITIGATION | Standard Detail LS                        | 6D-1. All pruning must be pe   |
| Please attach picture with application.  Idditional Requirements: All stumps must be ground the date of approval (see expiration date below ternational Society of Arboriculture (ISA) standards  SECTION  To appeal a permit denial before the City Council, contact the City Clerk's office within ten days from the date of this notice.  Call (510) 284-4060  Mitigation must b but before expired. | low). Install trees per City<br>s or ANSI 300.<br>TO BE FILLED OUT BY CITY.<br>REQUIRED MITIGATION | Standard Detail LS                        | 6D-1. All pruning must be pe   |



#### A PERMIT IS REQUIRED PER FMC 4-5100 UNDER THE FOLLOWING CONDITIONS:

| YOU DO      | need a tree removal permit if the tree meets <u>one or more</u> of the following size conditions:   |
|-------------|---|
| 000         | Any size DBH (any species**) if the tree was required or preserved through a previous development approval, 6" DBH* or larger (any species**) if on underdeveloped or vacant land, 10" DBH* or larger if native to Fremont***, or   |
|             | 18" DBH* or larger (any species**).   |
|             | D the tree is located on <u>one or more</u> of the following types of properties:   |
|             | Any City approved development on any size property were the tree was required or the tree was preserved,  |
|             | The front yard of any Single Family Home lot 10,000 square feet or less (a side yard facing a street on a corner lot is regulated as a front yard.),  |
|             | Any Single Family Home lot larger than 10,000 square feet, or   |
|             | Any non-Single Family Home lot in Fremont.  |
| YOU DO      | NOT need a permit if the tree is:   |
|             | ocated in the rear or side yard of any Single Family Home lot 10,000 square feet or less (unless specifically required by previous development approval or is listed the City Landmark Tree List.)  |
| Notes and D | efinitions:   |
| *           | DBH – Diameter at Breast Height (Trunk diameter measured four and one half feet from ground level).   |
|             | For multi-trunk trees, DBH is the sum total of all trunks added together (measured 4 ½ feet from ground level).   |
|             | For low branching trees with substantial branches below four and one half feet from ground level, DBH is measured below the lowest branch attachment.   |
| **          | Exceptions include commercial-type fruit or nut bearing trees, which DO NOT require a permit (except Walnuts and Olives are protected and therefore require permits),   |
| **          | *Trees Native to Fremont are regulated starting at 10 "DBH, and includes Oak, Redwood, Buckeye, Madrone, Sycamore, Big-Leaf Maple, Redbud, and Bay. Additionally, a list of non-native trees that have exceptional adaptability to Fremont and are treated as native trees, include Fremont Cottonwood, California Pepper, European |
|             | Olive, Black Walnut, and Deodar Cedar. For all other tree species refer to table above for permit requirements.   |

#### **CRITERIA FOR GRANTING PERMITS:**

The City promotes options for preservation of mature healthy trees whenever possible. Per FMC 4-5106, tree removal permit will be considered for approval if the tree: 1) is hazardous to person or property and cannot be corrected to be safe, 2) has a short life expectancy, 3) is a host to disease that endangers other trees, 4) is part of a group that is overcrowded, 5) makes reasonable development of the property impossible, 6) makes full enjoyment of an existing structure or utility (gas, water, etc.) impossible., or 7) has been damaged to the extent that it cannot be feasibly restored.

If a permit is granted, a 24" box size replacement tree will be required (15 gallon size tree is required for homeowners). The tree species should be of similar type and size as the tree removed. A subsequent arborist report or tree survey paid by the applicant may be required to determine if tree meets criteria for removal, such as described above.

#### INSTRUCTIONS FOR COMPLETING APPLICATION:

- If you have a development application pending or contemplated with the City, do not use this application.
   Application for tree removals will be considered together with your development.
- Fill out the top portion of the application on the opposite side of this sheet. A fee is not required. Incomplete applications will delay approval process or application may be returned.
- 3. Mail (front page only) or bring in person to the City Landscape Architect at:

City of Fremont, Engineering Division 39550 Liberty Street

Fremont, CA 94537-5006,

(or) E-mail pdf of complete application to rravenstad@ci.fremont.ca.us

- Include your phone number so city staff can call with questions.
- Expect two to four weeks for a fully processed application unless the City requires additional information.
   Applications must be made at least 15 days before proposed date for tree removal.
- 6. Call (510) 494-4700 for final inspection after replacement tree(s) is planted.



### Resources, Publications and Documents

- 1. Bay-Friendly Landscape Guidelines(Book), Alameda County Waste Management (akawww.stopwaste.org)
- 2. Water Use Classification of Landscape Species (WUCOLS), University of California cooperative Extension. (http://ucanr.edu/sites/WUCOLS)
- 3. City of Fremont Stormwater Treatment Requirements (https://city.fremont.gov/stormwaterpermit)
- 4. C.3 Stormwater Technical Guidance Manual, Alameda Countywide Clean Water Program (https://www.cleanwaterprogram.org/businesses/development.html)
- 5. State Water Resources Control Board. (http://www.waterboards.ca.gov)
- 6. Sunset Western Garden Book, Lane Publishing.
- 7. Plants and Landscapes for Summer Dry Climates (Book), East Bay Municipal Utility District
- 8. Trees and Development: A Technical Guide to Preservation of Trees During Land Development (Book), International Society of Arboriculture (Matheny, Clark)
- 9. California Irrigation Management Information Systems, State of California, Department of Water Resources, (www.cimis.water.ca.gov)
- 10. International Society of Arboriculture. (<u>www.isa-arbor.com</u>)
- 11. American Society of Consulting Arborists. (<u>www.asca-consultants.org</u>)
- 12. *Trees are Good.* Professional and consumer information on trees from International Society of Arboriculture (<a href="www.treesaregood.org">www.treesaregood.org</a>)
- 13. Calculate the ecological and financial benefit of your tree. I-Tree is based on USDA Forest Service "Statum" tree assessment tool. (http://www.treebenefits.com/calculator/index.cfm)




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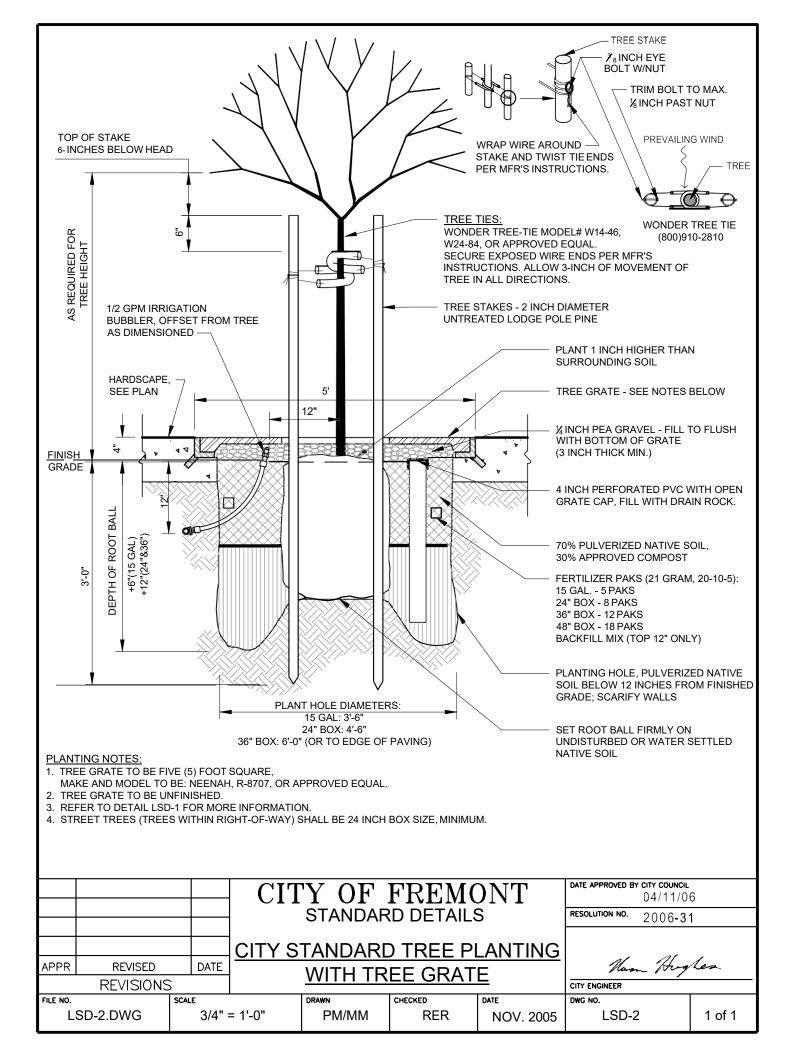



## LANDSCAPE STANDARD DETAILS (LSD) FOR CITY PROJECTS AND RIGHT-OF-WAY

#### Table of Contents


| DETAIL NO. | <u>TITLE</u>   |
|------------|--|
| LSD-1      | TREE PLANTING AND STAKING                            |
| LSD-2      | TREE PLANTING WITH TREE GRATE                        |
| LSD-3      | SHRUB AND GROUNDCOVER PLANTING                       |
| LSD-4      | SHRUB AND GROUNDCOVER LAYOUT                         |
| LSD-5      | STREET TREE CLEARANCES                               |
| LSD-6      | TREE CLEARANCES                                      |
| LSD-7      | MEDIAN COBBLE PAVING                                 |
| LSD-8      | MAINTENANCE BAND                                     |
| LSD-9      | TREE PROTECTION FENCING                              |
| LSD-10     | TEMPORARY TRUNK WRAP                                 |
| LSD-11     | Not used   |
| LSD-12     | TREE AND SHRUB PLANTING ON SLOPE                     |
| LSD-13     | TREE PLANTING GUIDE (LIST)                           |
| LSD-14     | IRRIGATION MATERIALS                                 |
| LSD-15     | IRRIGATION CONTROLLER CABINET w/ CALSENSE CONTROLLER |
| LSD-16     | BACKFLOW PREVENTOR UNIT                              |
| LSD-17     | BACKFLOW PREVENTOR UNIT CAGE                         |
| LSD-18     | IRRIGATION TRENCH                                    |
| LSD-19     | QUICK COUPLING VALVE IN BOX                          |
| LSD-20     | IRRIGATION WIRE SPLICE                               |
| LSD-21     | IRRIGATION ROTOR OR POP-UP                           |
| LSD-22     | IRRIGATION GATE VALVE                                |
| LSD-23     | REMOTE CONTROL VALVE W/ GATE VALVE                   |
| LSD-24     | MASTER VALVE AND FLOW SENSOR                         |
| LSD-25     | PRESSURE REDUCTION VALVE                             |
| LSD-26     | IRRIGATION WYE STRAINER                              |
| LSD-27     | LANDMARK TREE PLAQUE                                 |
| LSD-28     | LANDMARK TREE RAILING                                |
| LSD-29     | STORMWATER TREEWELL (2 pages)                        |
| LSD-30     | STORMWATER PLANTER (4 pages)                         |
| LSD-31     | STORMWATER TRASH CAPTURE INLET (3 pages)             |



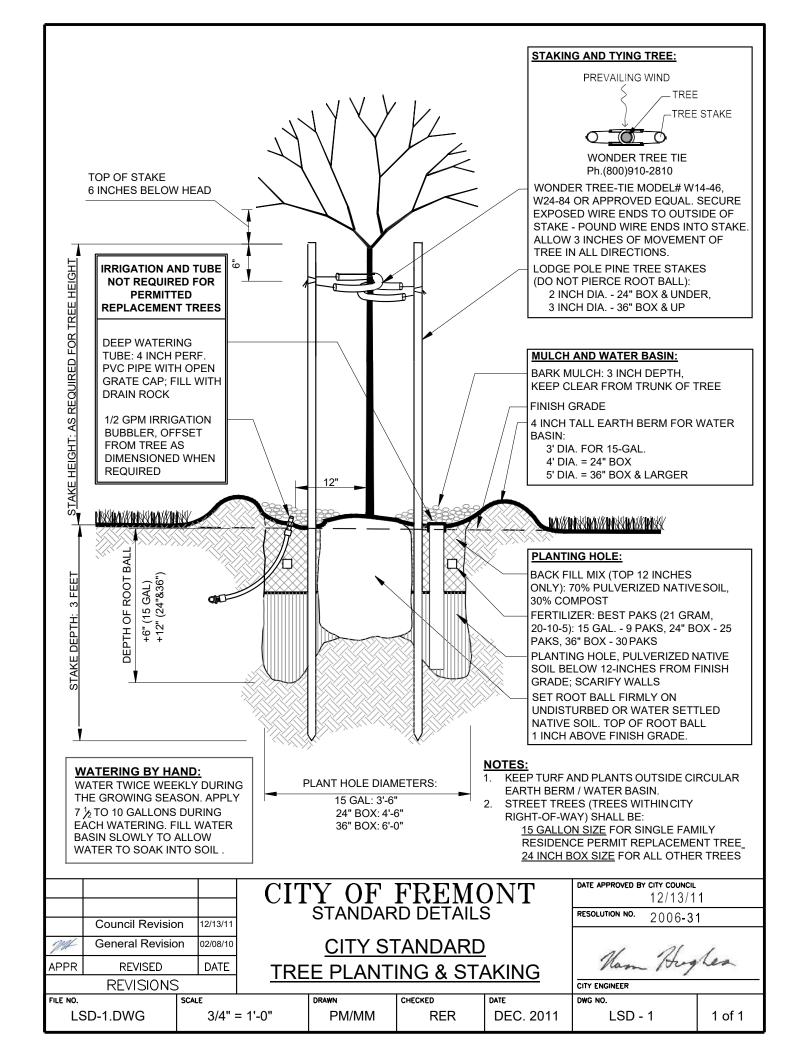

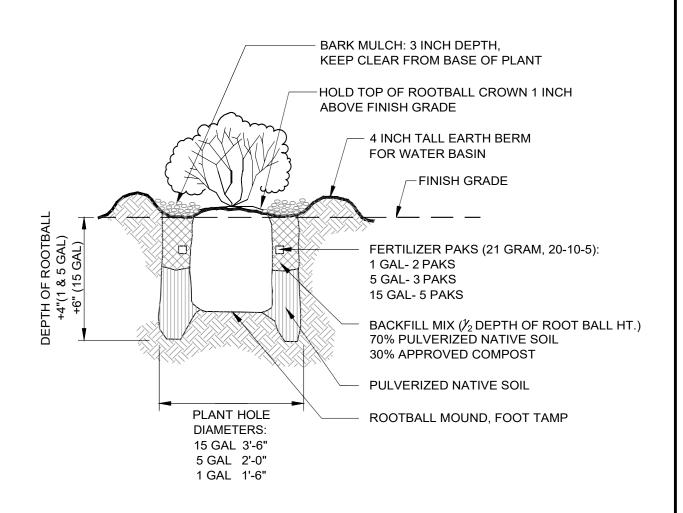

|           |         |       | CIT                   | 1 01 .   | FREMO        | <b>7 1 1 1</b>        | DATE APPROVED BY CITY COUNCIL 04/11/0 |        |  |
|-----------|---------|-------|-----------------------|----------|--------------|-----------------------|---------------------------------------|--------|--|
|           |         |       | STANDARD DETAILS      |          |              | RESOLUTION NO. 2006-3 | 1                                     |        |  |
|           |         |       |                       | CITY ST  |              |                       |                                       |        |  |
|           |         |       | CHDI                  | IR AND C | BUINDO       | 'O\/EB                |                                       |        |  |
| APPR      | REVISED | DATE  | SHRUB AND GROUNDCOVER |          |              |                       | Nam Hughen                            |        |  |
| REVISIONS |         |       |                       | PLAI     | <u>NTING</u> |                       | CITY ENGINEER                         |        |  |
| FILE NO.  |         | SCALE |                       | DRAWN    | CHECKED      | DATE                  | DWG NO.                               |        |  |
| LS        |         |       | = 1'-0"               | PM/MM/AK | RER          | NOV. 2005             | LSD-3                                 | 1 of 1 |  |

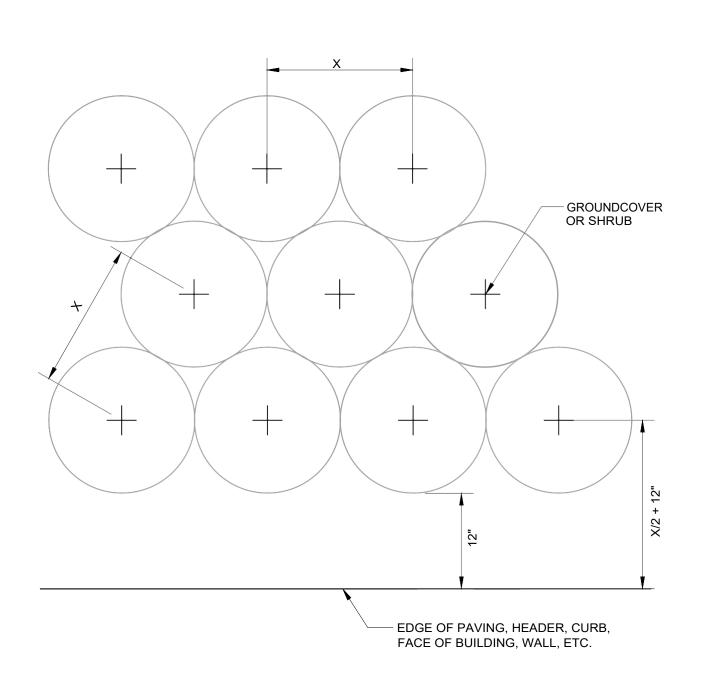


- 1. 'X' IS GROUNDCOVER AND SHRUB SPACING PER THE LANDSCAPE PLAN, PLANT LIST, AND LEGEND.
- 2. KEEP MULCH CLEAR OF PLANT BASE (SEE LSD-3 & LSD-12)

|          |                  |            | CIT     | Y OF     | FREMO      | ONT       | DATE APPROVED BY CITY COUNCIL 12/13/1 |        |
|----------|------------------|------------|---------|----------|------------|-----------|---------------------------------------|--------|
|          |                  |            |         | STANDAR  | RD DETAILS | S         | RESOLUTION NO. 2006-3                 | 1      |
|          | Council Revision | 12/13/11   |         | CITY ST  | ANDARD     | -         | 2000 0                                | '      |
| MA       | General Revision | n 03/17/11 | SHR     | UB AND C | ROUNDO     | OVER      | 11 11                                 | /      |
| APPR     | REVISED          | DATE       |         | PLANTIN  | G LAYOU    | T         | Nam Hug                               | hea    |
|          | REVISIONS        |            |         |          |            |           | CITY ENGINEER                         |        |
| FILE NO. |                  | SCALE      |         | DRAWN    | CHECKED    | DATE      | DWG NO.                               |        |
| LS       | SD-4.DWG         | 1" =       | : 1'-0" | PM/MM    | RER        | DEC. 2011 | LSD-4                                 | 1 of 1 |

#### MINIMUM STREET TREE CLEARANCES

- 1. STREET TREES SHALL BE LOCATED 8 FEET (MIN) FROM SANITARY SEWER, GAS, AND STORMWATER LINES.
- 2. STREET TREES SHALL BE LOCATED 5 FEET (MIN) FROM WATER, TELEPHONE AND ELECTRICALLINES.
- 3. STREET TREES SHALL BE LOCATED 5 FEET (MIN) FROM FIRE HYDRANTS.
- 4. STREET TREES SHALL BE LOCATED 15 FEET (MIN) FROM STREET LIGHTS.
- 5. STREET TREES SHALL BE LOCATED 8 FEET (MIN) FROM DRIVEWAYS AND 4 FEET (MIN) ATCUL-DE-SAC.
- 6. STREET TREES SHALL BE GENERALLY 35 FEET ON CENTER.
- 7. STREET TREES SHALL BE LOCATED 15 FEET (MIN) FROM CURB RETURNS.
- 8. MINIMUM ONE TREE PER LOT REQUIRED, AND TWO PER CORNER LOT.
- 9. IF LOT WIDTH EXCEEDS 60 FEET AT THE STREET, ONE TREE IS REQUIRED EVERY 35 FEET OF STREET, EXCLUDING LENGTH OF CURB RETURN.

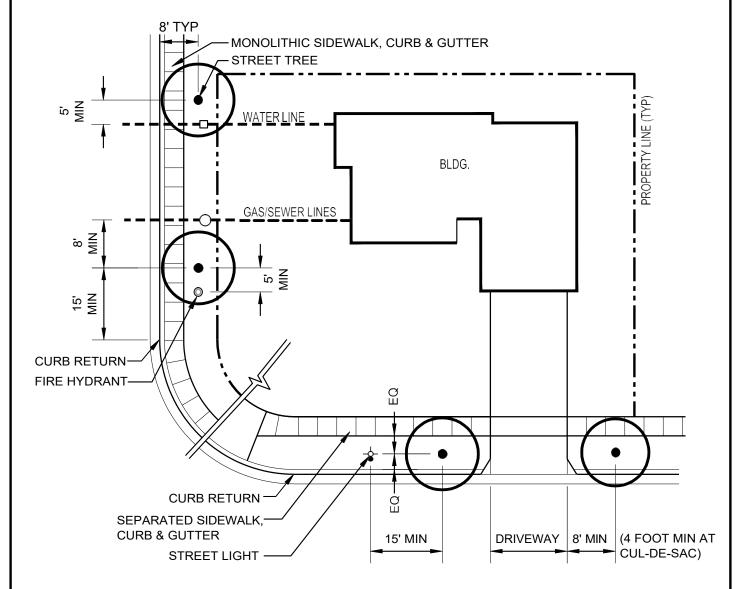


NOTE: CURRENT STANDARD DETAIL AT CITY ENGINEERING DIVISION SHALL PREVAIL

|          |           |       | CIT    | Y OF     |           | <b>7 1 1 2</b> | DATE APPROVED BY CITY COUNCIL 04/11/0 |        |
|----------|-----------|-------|--------|----------|-----------|----------------|---------------------------------------|--------|
|          |           |       |        | STANDAR  | D DETAILS | S              | RESOLUTION NO. 2006-3                 | 1      |
|          |           |       |        | CITY ST  | ANDARD    |                |                                       |        |
| APPR     | REVISED   | DATE  | STRE   | EET TREE | CLEARA    | NCES           | Nam Hug                               | Lea    |
|          | REVISIONS | S     |        |          |           |                | CITY ENGINEER                         | -      |
| FILE NO. |           | SCALE |        | DRAWN    | CHECKED   | DATE           | DWG NO.                               |        |
| LS       | D-05.DWG  | 1" =  | 20'-0" | PM/MM    | RER       | OCT. 2005      | LSD-5                                 | 1 of 1 |

#### MINIMUM TREE CLEARANCES FROM BUILDINGS

BRANCHES FROM MATURE TREES MAY NOT OVERHANG BUILDINGS AND ROOFS. ADEQUATE SPACE TO PLANT TREES ADJACENT TO BUILDINGS OR OTHER BUILT FEATURES MUST BE PROVIDED IN THE FOLLOWING MINIMUM WAYS:


- 1. SMALL TREES (TO 15 FEET TALL AT MATURITY) NO CLOSER THAN 6 FEET FROM BUILDING OR 2 FEET\* FROM PAVING, CURBS, OR WALLS WITH A MINIMUM PLANTING AREA 5 FEET WIDE.
- 2. MEDIUM TREES (TO 35 FEET TALL AT MATURITY) NO CLOSER THAN 10 FEET FROM BUILDING OR 3 FEET\* FROM PAVING, CURBS, OR WALLS WITH A MINIMUM PLANTING AREA 6 FEET WIDE.
- 3. LARGE TREES (ABOVE 35 FEET TALL AT MATURITY) NO CLOSER THAN 15 FEET FROM BUILDING ORE 3 FEET\* FROM PAVING, CURBS, OR WALLS WITH A MINIMUM PLANTING AREA 6 FEET WIDE, PREFERABLY
- 4. WHEN ROOF EAVES OR BUILDING PROJECTIONS EXTEND BEYOND FACE OF BUILDING, CLEARANCE SHALL BE MEASURED FROM EDGE OF PROJECTION TO CENTERLINE OF TREE.
- 5. UPPER STORY OVERHANGS AND BUILDING FEATURES MAY NOT EXTEND WITHIN MINIMUM CLEARANCE EXCEPT FOR MINOR ROOF EAVES.
- \* REFER TO CITY STANDARD DETAIL LSD-05 FOR REQUIRED SPACING FROM UTILITIES.

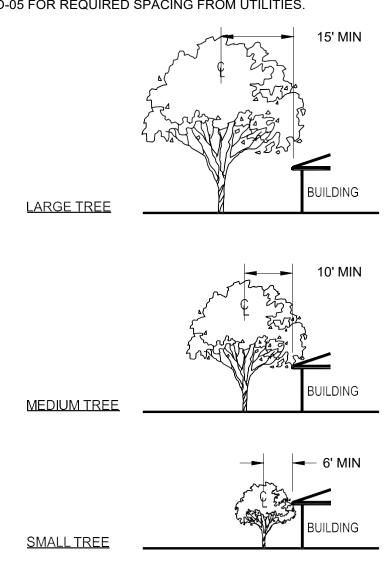

04/11/06

2006-31


1 of 1

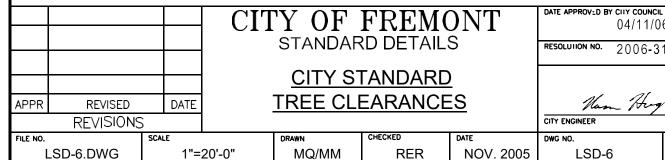

REVISIONS

LSD-7.DWG

- CURRENT STANDARD DETAIL AT CITY ENGINEERING DIVISION SHALL PREVAIL.
- 2. CROWN TO BE ROUNDED WITH NO SHARP GRADE BREAKS.
- 3. MINIMIZE VISIBLE EXPOSED GROUT AT COBBLE JOINTS.
- 4. SURFACE OF COBBLE FIELD TO BE SMOOTH AND FLAT TO GRADE WITHOUT VARIATION IN HEIGHT OF INDIVIDUAL COBBLES.
- 5. COBBLES WITH BREAKS OR FRACTURES ARE NOT ALLOWED.
- 6. ROCK SHALL BE 'SATURATED SURFACE MOIST' (SSM) PRIOR TO PLACEMENT.
- 7. CONCRETE MORTAR BED SHALL HAVE A CEMENT RATIO PER CUBIC YARD OF CONCRETE OF NOT LESS THAN 564 POUNDS; SLUMP MAX. OF 3"; AGGREGATE SIZE  $\mathcal{I}_4$ " MAXIMUM.
- 8. INTEGRAL COLOR ADMIXTURE: CHROMIX, ADOBE TAN, #C-21 BY L.M. SCOFIELD.

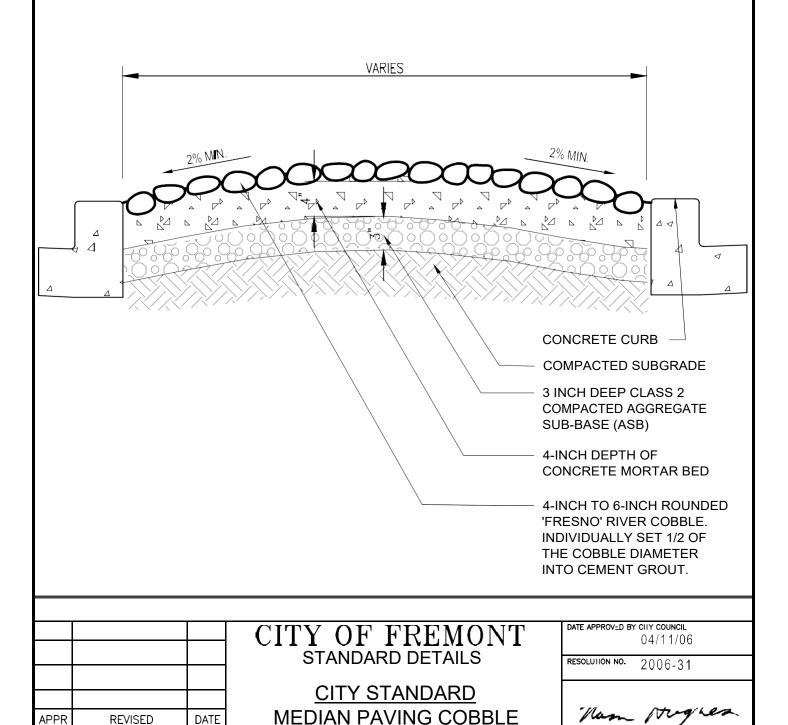

DRAWN

PM/MM

1" = 1'-0"

CHECKED


**RER** 

CITY ENGINEER
DWG NO.

LSD-7


1 of 1

NOV. 2005

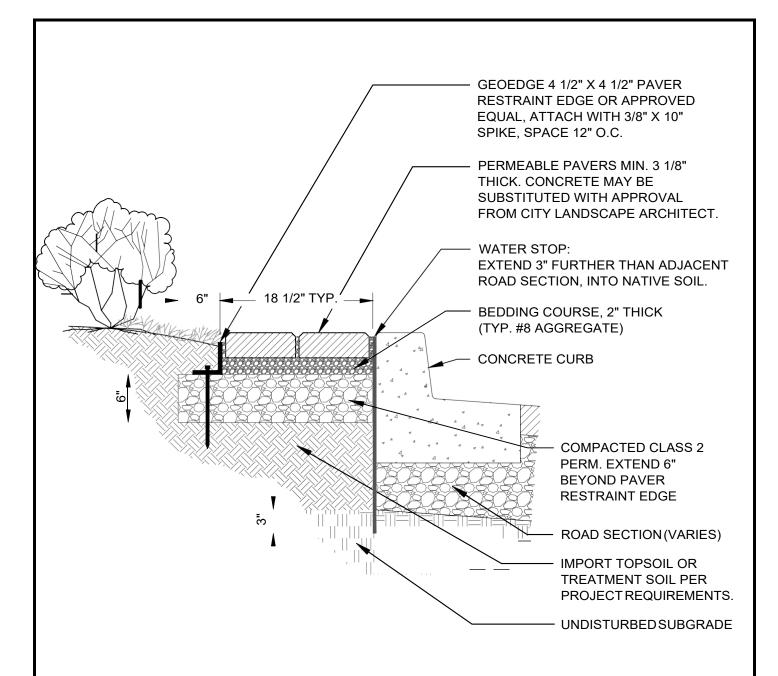

- 1. ON MEDIANS LESS THAN 14 FEET WIDE, REPLACE MAINTENANCE BAND WITH 18 INCH MINIMUM WIDTH PLANTING OF WALKABLE GROUNDCOVER.
- 2. IF CONCRETE, INSTALL DEEP JOINTS TO MATCH CURB & GUTTER DEEP JOINTS. SEE ENGINEERING STANDARD DETAIL 8 FOR DEFINITION OF DEEP JOINT.
- 3. FOR PAVERS WITHIN THE DRIPLINE OF AN EXISTING TREE, HAND EXCAVATE ALL AREAS.
  6" CLASS 2 PERM LAYER MAY BE REDUCED OR ELIMINATED IF NECESSARY. SEE LSD-9 FOR TREE PRESERVATION NOTES.
- 4. PAVERS TO BE: 6 X 9 X 3 1/8 CALSTONE PERMEABLE PAVING UNITS, COLOR: RUSTIC YELLOW STONE, UNLESS APPROVED BY THE CITY LANDSCAPE ARCHITECT.


|          |                  |            | СІТ      | Y OF     | FREMO      | ONT       | DATE APPROVED BY CITY COUNCIL | ='     |
|----------|------------------|------------|----------|----------|------------|-----------|-------------------------------|--------|
| MA       | General Revision | n 09/05/12 |          | STANDAF  | RD DETAILS | S         | RESOLUTION NO. 2006-3         | 1      |
|          | Council Revisio  | n 12/13/11 |          | CITY S   | TANDARD    | <u>)</u>  | 21 21                         |        |
| APPR     | REVISED          | DATE       | <u>N</u> | MAINTENA | ANCE BAI   | <u> </u>  | Nam Hug                       | Nea    |
|          | REVISIONS        |            |          |          |            |           | CITY ENGINEER                 |        |
| FILE NO. |                  | SCALE      | _        | DRAWN    | CHECKED    | DATE      | DWG NO.                       |        |
| L        | SD-8.DWG         | 1" =       | = 1'-0"  | PM/MM    | RER        | DEC. 2011 | LSD-8                         | 1 of 1 |

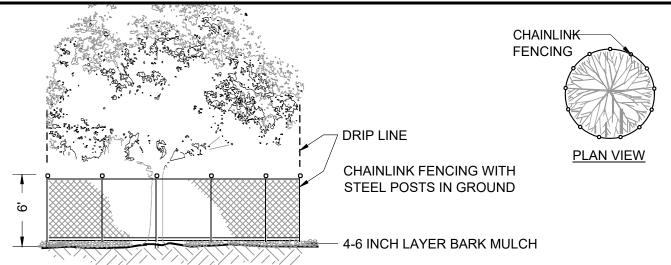

## TREE PROTECTION NOTES

- 1. CURRENT STANDARD DETAIL AT CITY ENGINEERING DIVISION SHALL PREVAIL.
- 2. TREE PROTECTION MEASURES MUST BE IN PLACE BEFORE CONSTRUCTION, DEMOLITION AND/OR GRADING ACTIVITIES COMMENCE. CITY OF FREMONT WILL STOP CONSTRUCTION IF TREE PROTECTION MEASURES ARE NOT IN PLACE AND MAINTAINED THROUGHOUT THE CONSTRUCTION PERIOD.
- 3. TREES CALLED OUT FOR PRESERVATION SHALL BE FENCED AT THE DRIPLINE. FENCING MAY OCCUR AT THE COMBINED DRIPLINES OF GROVES OF TREES. PLACE 4-6 INCH BARK MULCH BENEATH DRIPLINES OF TREES TO BE PRESERVED. KEEP BARK 2-3 FEET FROM TREE TRUNK.
- 4. FENCING SHALL BE 6 FEET TALL CHAIN LINK FENCING WITH STEEL POSTS EMBEDDED IN THE GROUND.
- 5. NO GRADING SHALL OCCUR WITHIN THE DRIPLINES/FENCED AREA OF EXISTING TREES.
- 6. NO CONSTRUCTION MATERIALS OR CONSTRUCTION VEHICLES MAY BE STORED WITHIN THE DRIPLINES/FENCED AREA OF EXISTING TREES.
- 7. CONSTRUCTION VEHICLES OR MACHINERY MAY NOT PASS BETWEEN TWO OR MORE EXISTING TREES IDENTIFIED FOR PRESERVATION IF THEIR CANOPIES ARE WITHIN 10 FEET OF TOUCHING. ADDITIONAL FENCING MAY BE REQUIRED BY THE CITY AS NEEDED.
- 8. THE CONTRACTOR IS REQUIRED TO HAVE AN ARBORIST CERTIFIED BY THE INTERNATIONAL SOCIETY OF ARBORICULTURE (ISA), APPROVED BY THE CITY, ON SITE IF SITE CONSTRUCTION EFFORTS REQUIRE REMOVAL OF EXISTING ROOTS OR BRANCH PRUNING. ROOTS APPROVED FOR CUTTING MUST BE CUT CLEANLY WITH A SAW. RIPPING OR SHREADING ROOTS SUBJECT TOFINE/PENALTY.
- 9. UNAUTHORIZED TREE REMOVAL IS SUBJECT TO REPLACEMENT EQUAL TO THE APPRAISED VALUE OF THE TREE LOST PER FMC 4-5108.
- 10. THE CONTRACTOR IS REQUIRED TO WATER, FERTILIZE AND ATTEND TO OTHER MAINTENANCE NEEDS OF EXISTING TREES TO MAINTAIN HEALTHY GROWTH THROUGHOUT THE CONSTRUCTION PERIOD. AN EARTH BERM MEASURING MINIMUM 6 FEET IN DIAMETER, AND 6 INCHES IN HEIGHT SHALL BE CONSTRUCTED AT THE BASE OF EACH TREE TO FUNCTION AS A TEMPORARY WATERING BASIN DURING THE CONSTRUCTION PERIOD. TREES SHALL BE WATERED ACCORDING TO WEATHER AND TREE SPECIES REQUIREMENTS.
- 11.IF TREES ARE BEING RELOCATED: RELOCATION OF EXISTING TREES SHALL OCCUR UNDER THE OBSERVATION AND DIRECTION OF A CERTIFIED ARBORIST APPROVED BY THE CITY OF FREMONT.
- 12. TRUNK WRAP PROTECTION SHALL OCCUR FOR TREES SITUATED IN SMALL TREE WELLS OR SIDEWALK PLANTERS. THIS FORM OF PROTECTION WILL BE ALLOWED BY APPROVAL FROM SENIOR LANDSCAPE ARCHITECT ONLY. REFER TO LSD-10.

|          |                 |            | СІТ     |         | FREMO      |           | DATE APPROVED BY CITY COUNCE |        |
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|          |                 |            |         | STANDAR | RD DETAIL: | 5         | RESOLUTION NO. 2006-3        | 1      |
|          |                 |            |         | CITY ST | ANDARD     |           |                              |        |
|          | Council Revisio | n 12/13/11 | TDE     |         |            |           | 11 11                        | 1      |
| APPR     | REVISED         | DATE       | IRE     | E PROTE | <u> </u>   | INCING    | Nam Huy                      | rea    |
|          | REVISIONS       |            |         |         |            |           | CITY ENGINEER                |        |
| FILE NO. |                 | SCALE      |         | DRAWN   | CHECKED    | DATE      | DWG NO.                      |        |
| L        | SD-9.DWG        | 1/8"       | = 1'-0" | PM/MM   | RER        | DEC. 2011 | LSD-9                        | 1 of 1 |

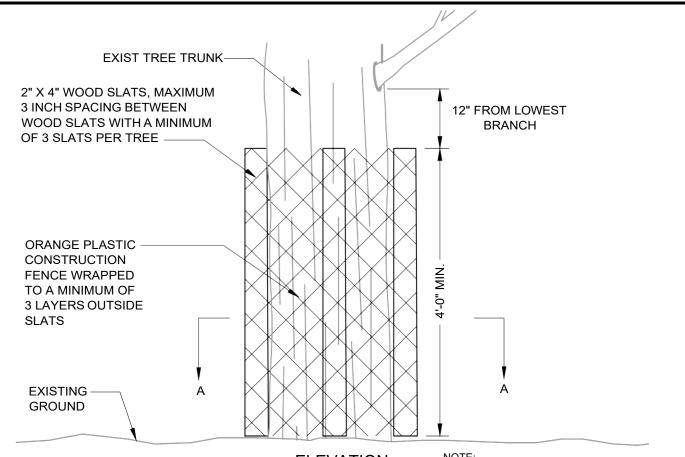


# **ELEVATION**

2" X 4" WOOD SLATS, MAXIMUM 3 INCH SPACING BETWEEN WOOD SLATS WITH A MINIMUM OF 3 SLATS PER TREE

**ORANGE PLASTIC** CONSTRUCTION **FENCE WRAPPED** TO A MINIMUM OF **3 LAYERS OUTSIDE** 

**SLATS** 


EXIST TREE TRUNK-

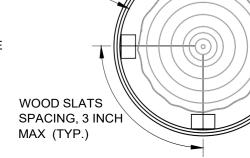


**SECTION A-A** 

- 1. WRAP ORANGE PLASTIC CONSTRUCTION FENCE ON TOP OF WOOD SLATS WITH AN OVERLAP OF 12 INCHES AND TIE WITH WIRE. SEE SECTION BELOW.
- 2. TEMPORARY TRUNK WRAP PROTECTION WILL BE ALLOWED ONLY BY APPROVAL FROM THE SENIOR LANDSCAPE ARCHITECT
- 3. DAMAGE TO BRANCHES & ROOTS SUBJECT TO FINE UP TO APPRAISED VALUE OF THE TREE, PER CITYTREE PRESERVATION ORDINANCE (FMC 4-5100).
- 4. REFER TO LSD-9 FOR ADDITIONAL TREE PROTECTION REQUIREMENTS APPLICABLE TO THIS DETAIL.
- 5. TRUNK WRAP SHALL BE IN PLACE NO MORE THAN 5 WORKING DAYS BEFORE WORK ADJACENT TO TREE, AND REMOVED NO MORE THAN 5WORKING DAYS AFTER WORK ADJACENT TO THE TREE, UNLESS OTHERWISE APPROVED BY THE CITY.

|          |                 |            | CII        | . 1 () 1       | FREM(                | <b>7111</b> | DATE APPROVED BY CITY COUNCIL<br>12/13/ | _      |
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|          |                 |            |            |                | RD DETAILS<br>ANDARD | 5           | RESOLUTION NO. 2006-3                   | 1      |
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|          | Council Revisio | n 12/13/11 | <u>TEM</u> | <u>IPORARY</u> | <u>TRUNK V</u>       | <u>VRAP</u> | 11 11                                   | 1      |
| APPR     | REVISED         | DATE       |            | PROTE          | ECTION               |             | Nam Hry                                 | rea    |
|          | REVISIONS       | )          |            |                |                      |             | CITY ENGINEER                           | _      |
| FILE NO. |                 | SCALE      |            | DRAWN          | CHECKED              | DATE        | DWG NO.                                 |        |
| LS       | D-10.DWG        | 3/4"       | =1'-0"     | PN/MM          | RER                  | DEC. 2011   | LSD-10                                  | 1 of 1 |

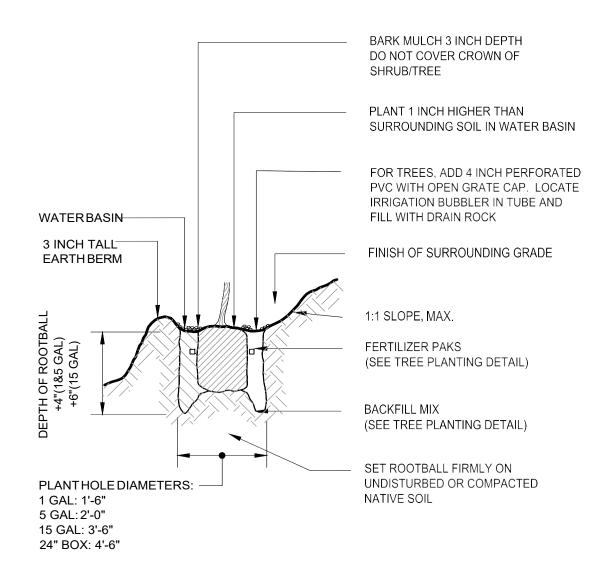

- 1. KEEP TURF AND PLANTS OUTSIDE THE EARTH BERM/WATER BASIN
- 2. SEE TREE PLANTING DETAIL FOR STAKING INFO.
- 3. THIS DETAIL TO BE REFERENCED, PER CITY STANDARD DETAIL LSD-11, FOR TREE PLANTING IN A VEGETATED BIOSWALE.

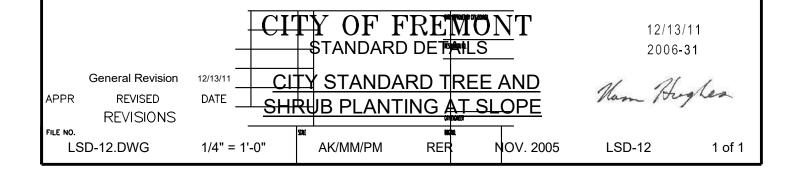

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| Norm      |   |  <del>                                      </del> |   |   |          |   |  |
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| Sycamore   | •   |  | •  | •  | •                                     | •  | ٠  | •           |  | _  |  | -  | •                 | •       |                   | •                               | •  |                                   |                |              |              |           |        |         |             |                    |          |          |        |   |  |           |                   |   |   | •   | •        | Ė   | -  |
| Sycamore   | •   |  | •  | •  | [•<br>[                               |  | ٠  | ŀ           | F  |  | ľ  | •  | L                 |         | ٠                 |                                 |  | ·                                 |                | •            | ٠            | ٠         | •      | •       | •           | i.                 | ŀ        | •        | ٠      | ٠                                       | •  | İ         | İ                 |   | İ   | İ   | t        | ŀ   | ļ.   |
| Neamore Plant Powering Pear  |   | +  |  |  |                                       |  |  | +           | +  | +  | 1  | +  |                   | +       |                   |                                 |  |                                   | +              | t            | ļ            | Ŧ         | -      |         | +           |                    | 1        | +        | Ŧ      |   | +  | ļ         | 1                 | +   | ļ   | 1   |          |   | +  |
| Plum   |   | +  | †  | •  | · [                                   |  | -  |             | +  | +  | 1  | †  | +                 | +       | 1                 | +                               | 1  | 1                                 | 1              | 1            | 1            | 1         | -      |         |             | H                  |          | -        | _      |   |  |           |                   | _   | 1   |   |          | 1   | -  |
| Par  | •   | •  | •  | •  |                                       | ‡  | ļ  |             |  |  |  |  | •                 | •       |                   | •                               | •  | _                                 |                |              |              |           |        | +       | +           | H                  | $\pm$    | Ŧ        | F      | 7                                       | +  | 1         | 1                 | ł   |   |   | 1        |   | +  |
| Pear   | •   | •  | •  | •  | -                                     |  | Ŀ  |             | <u>:</u>   | •  | •  | +  |                   |         |                   |                                 | •  |                                   |                |              |              |           |        | +       | +           |                    | $\pm$    | H        | Е      | $\blacksquare$                          | +  |           |                   | H   |   | ٠   |          | 1.1.  | +  |
| ar • •   |   | •  | •  | •  | ·<br>·<br>·                           |  |  |             |  | •  |  | <u>+</u>   |                   |         | •                 | •                               | •  | •                                 | -              |              |              |           |        |         |             |                    |          | $\vdash$ |        |   | +  |           |                   | Н.  | •   | •   |          | 1   | ++   |
| calleryana 'Red Si   |   | •  |  |  |                                       | <u> </u>   |  |             | •  |  |  | #  |                   | 1.      | •                 |                                 |  |                                   | Η.             | 1            | 1            |           |        |         |             | <del>       </del> | +        | H        | Ħ.     | 111.                                    | + + + •  |           |                   | H.  | •   |   |          | <u> </u>  | +++  |
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| 1  |   | +  | +  |  | •                                     |  |  |             |  |  |  | 1111   |                   |         |                   |                                 |  |                                   |                |              |              |           |        |         | 1           |                    |          |          |        |   |  | 1         |                   |   | •   | •   |          |   | ++++++   |
| Live Oak   | •   |  | •  |  |                                       | • • • • •  |  |             |  |  |  |  |                   | - - -   |                   |                                 |  |                                   |                |              | 111          |           |        |         | 1           |                    |          |          |        |   |  | 1 1 1 1   |                   |   |   |   |          | <del>                                      </del> | +++++++  |
|  |   |  | •  | •  |                                       |  |  |             |  |  | • • •  |  |                   | · 1     |                   |                                 •   |   |          | <del>                                      </del> | <del>                                      </del>  |
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|  | •   | •  | •  |  |                                       •   |   |          |   |  |
| · Idaho Locust   | •   | <u>·</u>   |  |  |                                       |  |  |             |  |  |  |  |                   |         | • • • • • • • • • |                                 |  |                                   |                |              |              |           |        |         |             |                    |          |          |        |   |  |           |                   | <del>                                     </del>  |   |   |          |   |  |
|  |   | -  |  |  <del>                                     </del>  | •   |   |          |   |  |
|  |   | -  |  |  | · · · · · · · · · · · · · · · · · · · |  |  | OB SQUICHUES. COBST NEWWOOD  |   | -  |  |  <del>                                     </del>  |   |   |          |   |  |
| III SCOIECTUIN: CHIRGSE I BIROW  |   | -  | • • • •  |  |                                       | phora japonica 'Regent': Japanese Pagoda   | -   | •  |  |  <del>                                     </del>  |   |   |          |   |  |
| • • • • • • • • • • • • • • • • • • •  | -<br>-  |  |  <del>                                     </del>  |   |   |          |   |  |
| istania larrina. Swamm Myrrlls   | <u>-</u>  | • •  |  |  <del>                                     </del>  |   |   |          |   |  |
|  | •   | • • •  |  |  <del>                                     </del>  |   |   |          |   |  |

TREE CHOICES ARE NOT LIMITED TO THIS LIST. THIS LIST IS ONLY A GUIDE.

|      | Council Revision | 12/13/11 |
|------|------------------|----------|
| APPR | REVISED          | DATE     |
|      | REVISIONS        |          |

# CITY OF FREMONT STANDARD DETAILS CITY STANDARD TREE PLANTING GUIDE LIST

DATE APPROVED BY CITY COUNCIL 12/13/11


RESOLUTION NO. 2006-31


CITY ENGINEER

ILE NO. SCALE DRAWN CHECKED DATE DWG NO.

LSD-13.DWG NONE MM RER DEC. 2011 LSD-13 1 of 1


| STANDARD<br>SYMBOL | DESCRIPTION   | MANUFACTURER                    | MODEL # (if applicable)   | COMMENTS   | LANDSCA<br>STANDAF<br>DETAIL |
|--------------------|---|---------------------------------|---|--|------------------------------|
| ©                  | Irrigation Controller w/ Enclosure  | Calsense                        | ET 2000e  | w/ all applicable software<br>as required by the city,<br>and dome antenna     | LSD-15                       |
|                    | Irrigation<br>Controller<br>Enclosure   | Calsense<br>Enclosure           | SSE-R   | Heavy-Duty Stainless Stee  | l LSD-15                     |
| H                  | Reduced Pressure-Principl<br>Backflow Preventer with<br>cage and concrete pad | e<br>Febco                      | 825-Y   |  | LSD-16                       |
|                    | Backflow Assembly<br>Cage   | Guardshack                      | GS Series   | Powdercoat Black   | LSD-1                        |
|                    | Irrigation Trench -<br>Mainline   |                                 | Sch. 40 PVC for 2" & less<br>Class 315 PVC for 2-1/2" & larger        | 24" below fin. grade   | LSD-18                       |
|                    | Irrigation Trench -<br>Lateral line   |                                 | Class 200 PVC for 1½" and greater Sch. 40 PVC for line 1" & smaller   | 18" below fin. grade   | LSD-18                       |
|                    | Sleeves   |                                 | Class 315 PVC   | Refer to LSD-18 for depth and size   | LSD-1                        |
| •                  | Quick-Coupling Valve (in box)   | Hunter                          | HQ-44LRC-AW<br>HR-44A   | Winged body w/ 1" key,<br>locking cover, and key                               | LSD-1                        |
|                    | Quick-Coupling<br>Valve Box   | Carson<br>Pentek                | 910 Lockable<br>Superflexon   | 10" Round box w/ lid   | LSD-1                        |
|                    | Wire Splice   | Scotchlok<br>Y-spring connector |   | Install per detail LSD-20  | LSD-2                        |
|                    | Turf Sprinklers   | Hunter                          | Super 700C Series<br>I-40 OR I-20 365-XX, 360 d, ADJ                  | Large Turf Areas   | LSD-2                        |
|                    | Turf Sprinklers   | Toro                            | 640 Series  | Large Turf Areas   | LSD-2                        |
|                    | Turf Sprinklers   | Toro                            | 570Z-6P/12P-O-T Precision Series                                      | Small Turf Areas   | LSD-2                        |
|                    | Shrub/Groundcover   | Toro                            | 570Z-6P/12P-O-T Precision Series                                      | Shrub/Groundcover Areas  | LSD-2                        |
|                    | Shrub Bubblers  | Toro                            | PC-FB-25  | Shrubs   |                              |
|                    | Tree Bubblers   | Toro                            | PC-FB-50  | Trees  | LSD-0                        |
| ×                  | Gate Valve (in box)   | Nibco                           | T-113   |  | LSD-2                        |
|                    | Gate Valve Box  | Carson<br>Pentek                | 910 Lockable<br>Superflexon   | 10" Round box w/ lid   | LSD-2                        |
| •                  | Remote Control<br>Valve (in box)  | Griswold                        | 2000 Series NC - Solenoid Valve<br>2230 Series NC - Pressure Reducing | NC = Normally Closed   | LSD-2                        |
|                    | Remote Control<br>Valve Box   | Carson<br>Pentek                | 1324 Lockable<br>Superflexon  | 13" X 18" box w/ lid   | LSD-2                        |
| Y                  | 'Y' Strainer  | Febco                           | 650A 1/2"-2"  |  | LSD-2                        |
|                    | Pressure Reducing<br>Valve  | Febco/Wilkins/Watts             | XXX   |  | LSD-2                        |
| FS                 | Flow Sensor   | Calsense                        | FM-1B   |  | LSD-2                        |
| MV                 | Master Valve  | Griswold                        | 2160 Series NO - Solenoid Valve                                       | NO = Normally Open   | LSD-2                        |
|                    | nbols shown are ci  | ty standard fo                  |   | NO = Normally Open  DATE APPROV_D BY CITY COUNCY 12/13/  RESOLUTION NO. 2006-3 | ii.<br>11                    |
| ./                 | Revision 12/13/11   | <b></b>                         | TAND 4 7 7  |  |                              |
| PR REV             | Revision 6/07/10 /ISED DATE   |                                 | STANDARD<br>ON MATERIALS  | Nam Hu   | gles                         |
|                    | CIONO I   | /                               | · · · · · · · · · · · · · · · · · · ·                                 | OUTH ENGINEED  |                              |
| REVI               | SIUNS SCALE   | DRAWN                           | CHECKED DATE  | CITY ENGINEER DWG NO.  | 1                            |

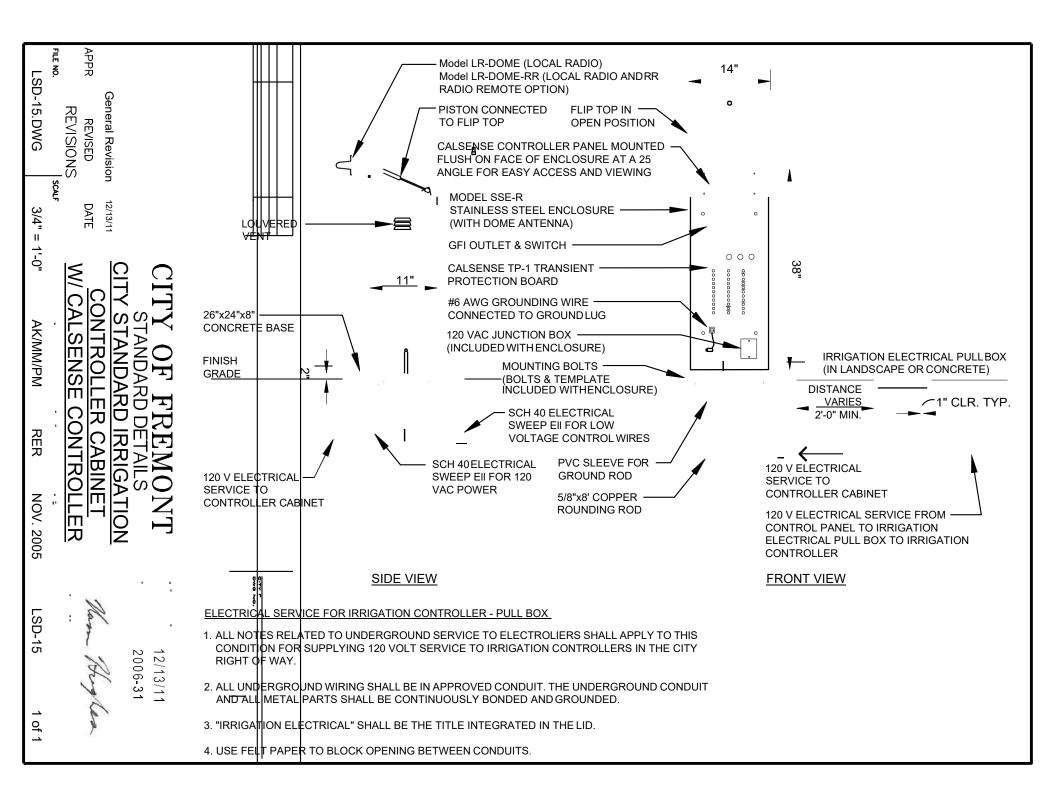

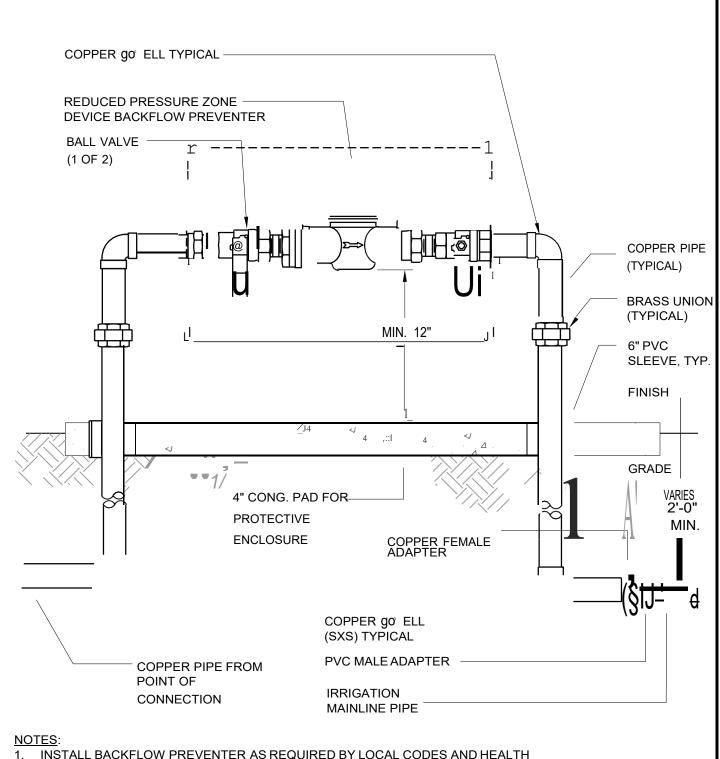

- 1. INSTALL BACKFLOW PREVENTER AS REQUIRED BY LOCAL CODES AND HEALTH DEPARTMENT. VERIFY LOCAL REQUIREMENTS PRIOR TO INSTALLATION.
- 2. INSTALL FREEZE PROTECTION JACKET AND CAGE. SEE CITY STANDARD DETAIL LSD-17 FOR CAGE DETAIL.
- 3. REFER TO CITY STANDARD DETAIL LSD-14 FOR ALL MATERIALS

|          |                          |             | CIT  | Y OF I                      | FREMORD DETAILS | <b>O</b> - 1 - | DATE APPROVED BY CITY COURT 12/13/1 RESOLUTION NO. 2006-31 | .1       |
|----------|--------------------------|-------------|------|-----------------------------|-----------------|----------------|--|----------|
| APPR     | MISC REVISION<br>REVISED | S 9/09 DATE |      | <u>/ STANDA</u><br>KFLOW PI |                 |                | Nam Hog  | lea      |
|          | REVISIONS                | 9           |      |                             |                 |                | CITY ENGINEER  |          |
| FILE NO. |                          | SCALE       |      | DRAWN                       | CHECKED         | DATE           | DWG NO.  |          |
| LS       | D-16.DWG                 | 1" = 1      | '-0" | PM/MM                       | RER             | NOV. 2005      | LSD-16   | 16 of 27 |

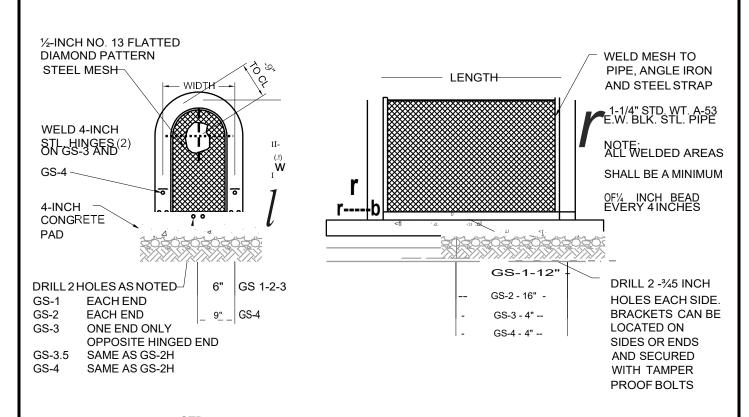



| SID.<br>SIZES | CENTERLINE DIMENSIONS |               | WEIGHT |
|---------------|-----------------------|---------------|--------|
| GS5           | 12"W x 18"H x 12"L    | LIFT OFF UNIT | 35     |
| GS-1          | 12"W x 24"H x 24"L    | LIFT OFF UNIT | 40     |
| GS-2          | 12"W x 24"H x 32"L    | LIFT OFF UNIT | 45     |
| GS-3          | 12"W x 24"H x 42"L    | HINGED UNIT   | 51     |
| GS-4          | 18"W x 30"H x 48"L    | HINGED UNIT   | 67     |

GS = POWDER-COATED STEEL GUARDSHACK OR APPROVED EQUAL

- 1. AFTER ALL WELDING, ENTIRE UNIT SHALL BE PROCESSED WITH IRON PHOSPHATE PRE-TREATMENT. ELECTROSTATIC APPLICATION OF POWDER SHALL BE FUSION BONDED. POWDERCOAT COLOR SHALL BE <u>BLACK</u>.
- 2. ALL BOLTS FOR HINGES AND HASPS SHALL BE ZINC-PLATED TAMPER PROOF, EXCEPTION USE SS HARDWARE FORSS UNITS. SS = STAINLESS STEEL
- 3. REFER TO SPECIFICATIONS FOR MODEL NUMBER
- 4. REFER TO CITY STANDARD DETAIL LSD-14 FORALL MATERIALS


|          |           |       | CI      | <b>FY OF</b>   |               |           | DATE APPROVED BY CIIY COU<br>12/13/1 | -      |
|----------|-----------|-------|---------|----------------|---------------|-----------|--------------------------------------|--------|
|          |           |       |         | _              | RD DETAIL:    | _         | RESOLUTION NO. 2 Q Q6 _3 1           |        |
|          |           |       |         | <u>CITY ST</u> | ANDARD        |           |                                      |        |
|          |           |       | BA      | CKFLOW         | <b>PREVEN</b> | TER       | 11 11                                | 1.     |
| APPR     | REVISED   | DATE  |         | LINIT EN       | CLOSURE       |           | nam Hug                              | rea    |
|          | REVISIONS | 3     |         | OITH LIT       | <u> </u>      | <b>=</b>  | CIIY ENGINEER                        |        |
| FILE NO. |           | SCALE |         | DRAWN          | CHECKED       | DATE      | DWG NO.                              |        |
| L:       | SD-17.DWG | 1/2"  | = 1'-0" | AK/MM/PN       | RER           | NOV. 2005 | LSD-17                               | 1 of 1 |

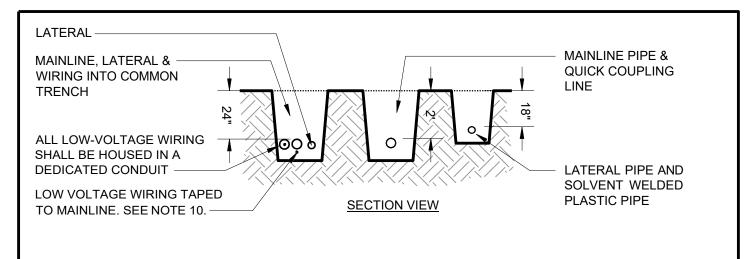

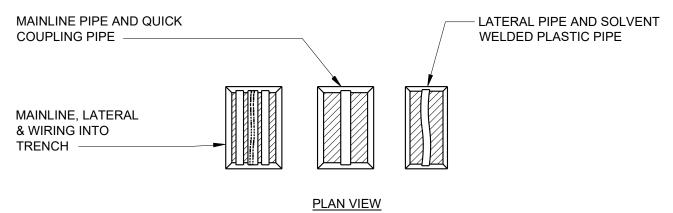

- 1. SLEEVE BELOW ALL HARDSCAPE ELEMENTS WITH CLASS 315 PVC TWICE THE DIAMETER OF THE PIPEOR WIRE CONDUIT WITHIN; BURIAL DEPTH FOR SLEEVES BELOW FINISHED GRADE ARE AS FOLLOWS:
  - 42 INCH MINIMUM UNDER THOROUGHFARE AND STREETS
  - 24 INCH MINIMUM UNDER PLANTER AREA
  - 24 INCH MINIMUM UNDER PARKING LOT
  - 18 INCH MINIMUM UNDER SIDEWALK
  - 36 INCH MINIMUM UNDER TRAFFIC CIRCLES (RESIDENTIAL AREAS)
- 2. ALL SLEEVE BELOW HARDSCAPE SHALL EXTEND 24 INCHES BEYOND HARD SURFACE EDGES.
- 3. FOR PIPE AND WIRE BURIAL DEPTHS, SEE SPECIFICATIONS, MAINLINE SHALL HAVE MINIMUM COVER OF 24 INCHES, LATERAL SHALL HAVE MINIMUM COVER OF 18 INCHES.
- 4. SCH 40 PVC FOR MAINLINE 2 INCHES OR SMALLER.
- 5. CLASS 315 PVC FOR MAINLINE 2 1/2 INCHES AND LARGER.
- 6. CLASS 200 PVC FOR 2 INCH LATERAL LINES AND SMALLER.
- 7. SCH 40 PVC FOR QUICK COUPLING LINE 1 INCH MIN. TO 2 INCH MAXIMUM
- 8. TRENCH BACKFILL SHALL BE NATIVE MATERIAL, COMPACT TO 90% MINIMUM, RELATIVE COMPACTION UNLESS UNDER CONCRETE OR ASPHALT. USE TRENCH BACKFILL PER CITY SPECIFICATION 11A AND 11B UNDER CONCRETE OR ASPHALT.
- 9. REFER TO DETAIL LSD-14 FOR IRRIGATION MATERIALS LIST.
- 10. IF APPROVED IN WRITING FROM THE CITY'S LANDSCAPE ARCHITECT, CONTROL WIRE MAY BE INSTALLED WITHOUT CONDUIT. INSTEAD, RUN WIRING BENEATH MAINLINE. TAPE AND BUNDLE AT 10 FOOTINTERVALS. TIE A 24 INCH LOOP IN ALL WIRING AT CHANGES OF DIRECTION OF 30 INCHES OR GREATER. UNTIE AFTER ALL CONNECTIONS HAVE BEEN MADE.

|          |                  |                    | СІТ      |           | FREMORD DETAILS   | <b>7 1 1 1</b> | DATE APPROVED BY CITY COUNCIL 12/13/1  RESOLUTION NO. 2006-3 | 1      |
|----------|------------------|--------------------|----------|-----------|-------------------|----------------|--|--------|
| APPR     | Council Revision | n 12/13/11<br>DATE | 11       |           | ANDARD<br>N TRENC |                | Nam Hug  | Lea    |
|          | REVISIONS        | ;                  | <u>"</u> | 1110/1110 | // IIII           | <u>/1 1</u>    | CITY ENGINEER  |        |
| FILE NO. |                  | SCALE              |          | DRAWN     | CHECKED           | DATE           | DWG NO.  |        |
| LS       | SD-18.DWG        | 1/4"               | = 1'-0"  | AK/MM/PM  | RER               | DEC. 2011      | LSD-18   | 1 of 1 |

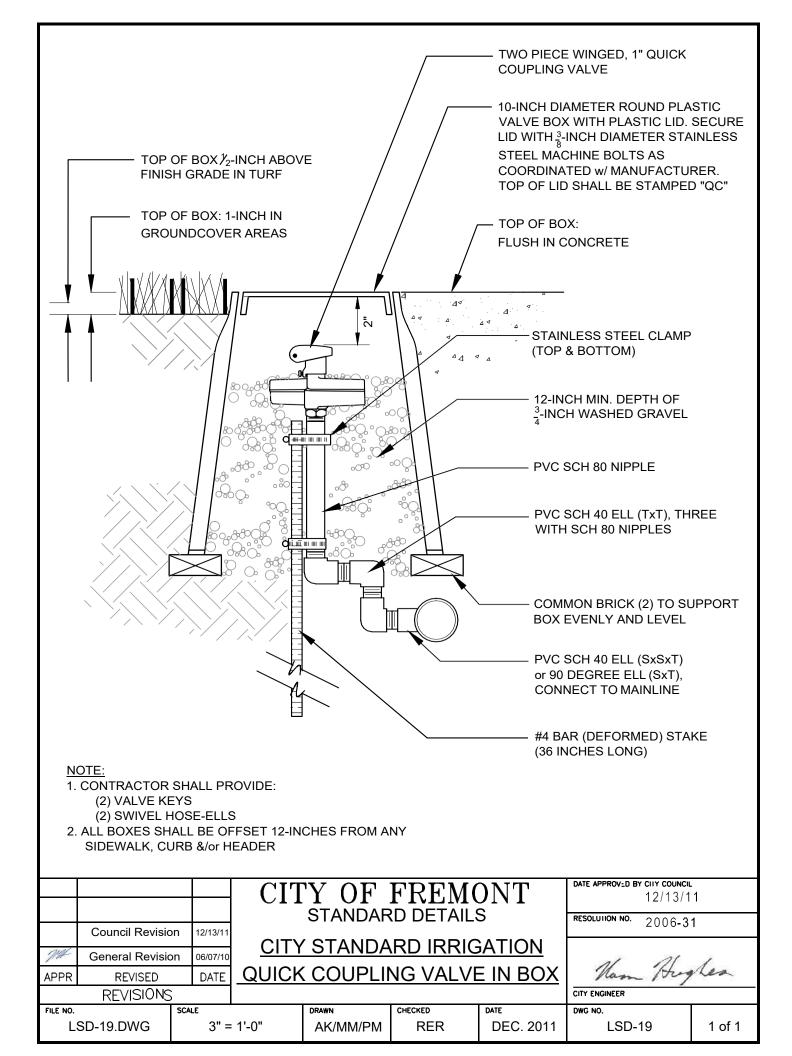

STEP 1: STRIP WIRES½ INCH FROM ENDS.


STEP 2: APPLY SCOTCHLOK YSPRING CONNECTOR IN A CLOCKWISE DIRECTION.






STEP 3: INSERT SPLICE FILLED TO BOTTOM OF GEL-FILLED TUBE, CHECK TO MAKE SURE CONNECTOR HAS BEEN PUSHED PAST LOCKING FINGERS AND IS SEATED AT BOTTOM OF TUBE.


STEP 4: POSITION WIRES IN WIRE CHANNELS AND CLOSE INSULATOR TUBE COVER.

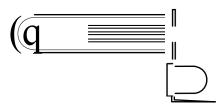

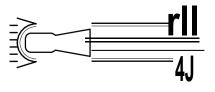


- 1. MAXIMUM WIRE SIZES PER CONNECTOR ARE 3-#14'S OR 2-#12'S
- 2. REFER TO CITY STANDARD DETAIL LSD-14 FOR MATERIALS

|          |           |          | CIT       | YOF               |                        |           | DATE APPROVED BY CITY COUNTY 12/13/1 |        |
|----------|-----------|----------|-----------|-------------------|------------------------|-----------|--------------------------------------|--------|
|          |           |          |           | STANDAR           | RESOLUTION NO. 2006-31 | 1         |                                      |        |
|          |           |          |           |                   | TANDARI                | _         | 11 11                                | 1      |
| APPR     | REVISED   | DATE     | <u>IR</u> | <b>RIGATION</b>   | WIRE SP                | LICE      | Nam Hug                              | Rea    |
|          | REVISIONS | 6        |           |                   |                        |           | CITY ENGINEER                        |        |
| FILE NO. | SD-20.DWG | SCALE NO | ONE       | DRAWN<br>AK/MM/PM | CHECKED<br>RER         | NOV. 2005 | DWG NO.<br>LSD-20                    | 1 of 1 |

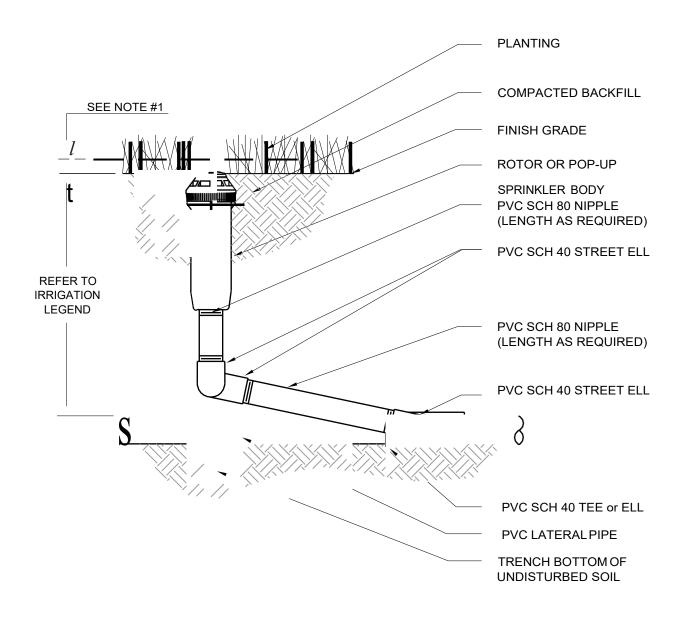


- 1. INSTALL TOP OF POP-UP SPRINKLER 1 INCH ABOVE FINISHED GRADE IN SHRUB AREAS AND FLUSH WITH GRADE IN TURF AREAS.
- 2. ROTORS SHALL BE INSTALLED FLUSH IN TURF AREAS.
- 3. REFER TO CITY STANDARD DETAIL LSD-14 FOR MATERIALS
- 4. INSTALL A MINIMUM OF 9" FROM EDGE OF PAVEMENT IN SHRUB AREAS AND 2" IN TURF AREAS.


|          |                |      | CIT          | CITY OF FREMONT STANDARD DETAILS |                     |           |                   | NCIL<br>1 |
|----------|----------------|------|--------------|----------------------------------|---------------------|-----------|-------------------|-----------|
| APPR     | REVISED        | DATE | <u>IRRIG</u> | CITY S'<br>ATION RO              | TANDARD<br>TOR OR I |           | Nam Hug           | lea       |
|          | REVISION       | S    |              |                                  |                     |           | CITY ENGINEER     |           |
| FILE NO. | FILE NO. SCALE |      | ONE          | DRAWN AK/MM/PM                   | CHECKED<br>RER      | NOV. 2005 | DWG NO.<br>LSD-21 | 1 of 1    |

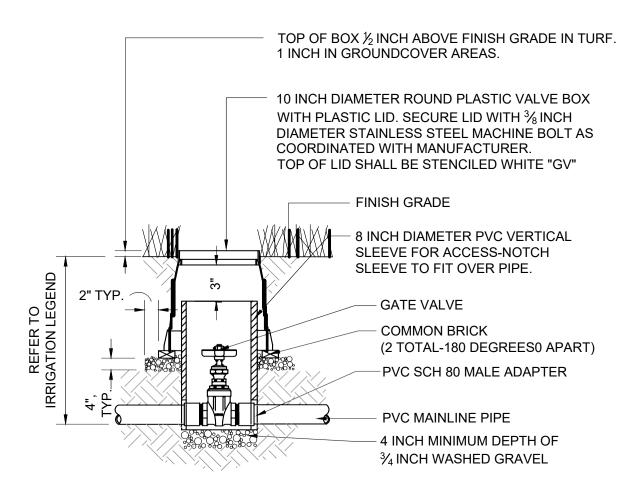


1. REFER TO CITY STANDARD DETAIL LSD-14 FOR ALL MATERIALS

|            |           |       | CIT                   | CITY OF FREMONT |         |             |                       | VI 0 1 V I |  |  |
|------------|-----------|-------|-----------------------|-----------------|---------|-------------|-----------------------|------------|--|--|
|            |           |       | STANDARD DETAILS      |                 |         |             | RESOLUTION NO. 2006-3 | 1          |  |  |
|            |           |       |                       | CITY S1         | . 26    |             |                       |            |  |  |
| APPR       | REVISED   | DATE  | IRRIGATION GATE VALVE |                 |         |             | Lea                   |            |  |  |
|            | REVISIONS |       | ILL                   | RIGATION        | GAIL VA | <u> LVE</u> | CITY ENGINEER         |            |  |  |
| FILE NO.   |           | SCALE |                       | DRAWN           | CHECKED | DATE        | DWG NO.               |            |  |  |
| LSD-22.DWG |           | 1-1/2 | " = 1'-0"             | AK/MM/PM        | RER     | NOV. 2005   | LSD-22                | 1 of 1     |  |  |

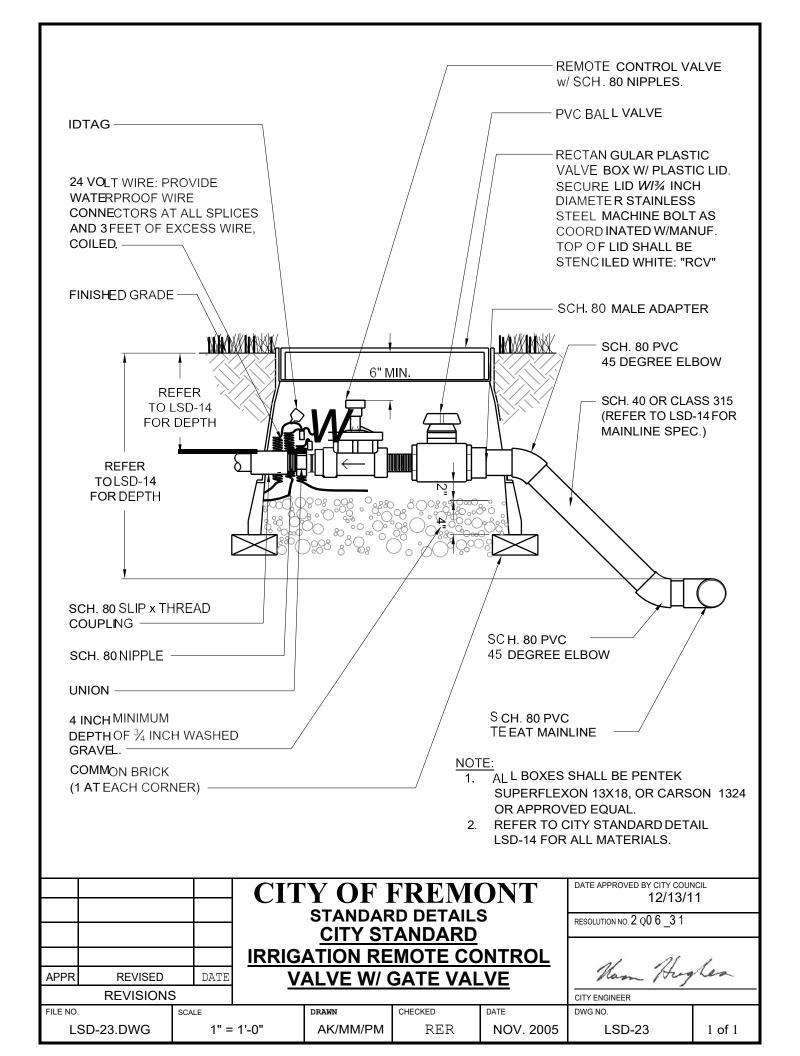


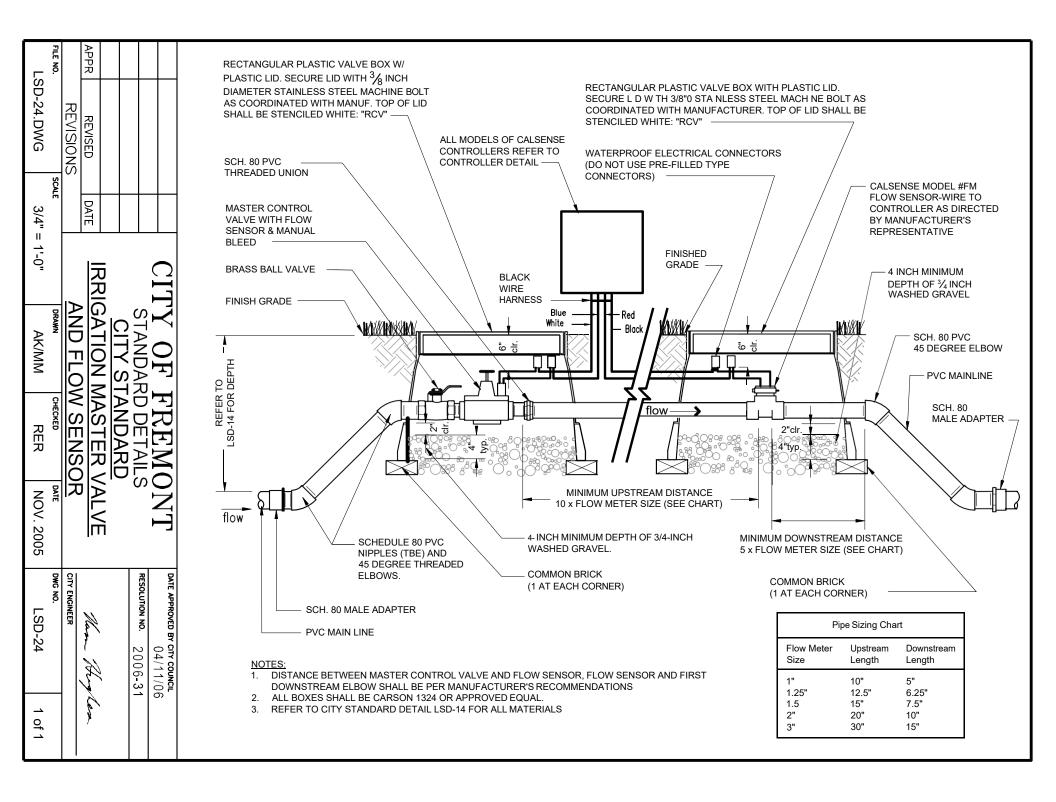

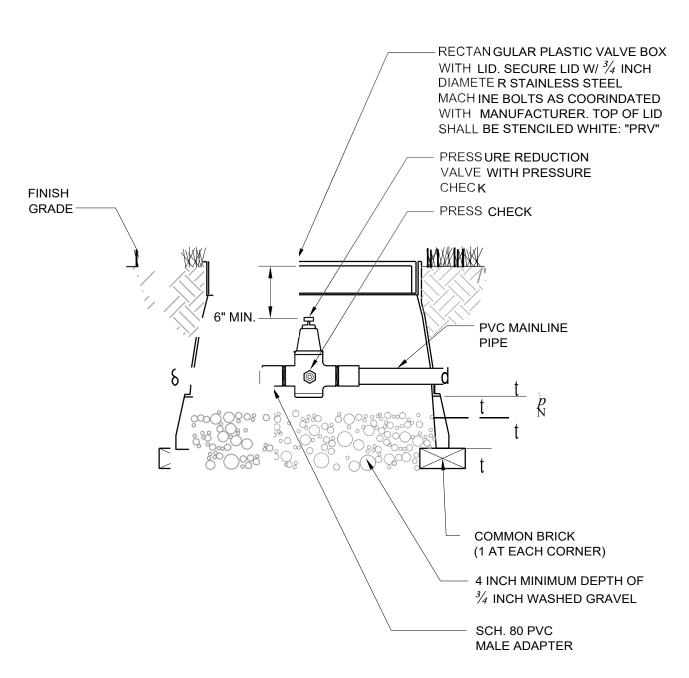

- 1. PRESSURE REDUCING VALVE BODY SHALL BE IRON; SEAT SHALL BE STAINLESS STEEL; INTEGRAL STRAINER SHALL BE STAINLESS STEEL; STEM SHALL BE BRASS; AND, DISK SHALL BE BRASS.
- 2. ALL BOXES SHALL BE PENTEK SUPERFLEXON 13X18, CARSON 1324 OR APPROVED EQUAL.
- 3. REFER TO CITY STANDARD DETAIL LSD-14 FOR ALL MATERIALS


|          |                 |       | CIT       | YOF                |                            |           | DATE APPROVED BY CITY COUNTY 12/13/1 | -      |
|----------|-----------------|-------|-----------|--------------------|----------------------------|-----------|--------------------------------------|--------|
|          |                 |       |           | STANDAR<br>CITY ST | RESOLUTION NO. 2 Q Q6 _3 1 |           |                                      |        |
|          |                 |       | <u>IR</u> | RIGATIO            | N PRESSI                   | JRE       | 11 11                                | 1.     |
| APPR     | REVISED         | DATE  |           | REDUCTI            | ON VALV                    | Έ         | nam Hug                              | hes    |
|          | REVISIONS       |       |           |                    | <u> </u>                   | <u>—</u>  | CITY ENGINEER                        |        |
| FILE NO. |                 | SCALE |           | DRAWN              | CHECKED                    | DATE      | DWG NO.                              |        |
| LS       | LSD-25.DWG 1" : |       | 1'-0"     | AK/MM/PM           | RER                        | NOV. 2005 | LSD-25                               | 1 of 1 |

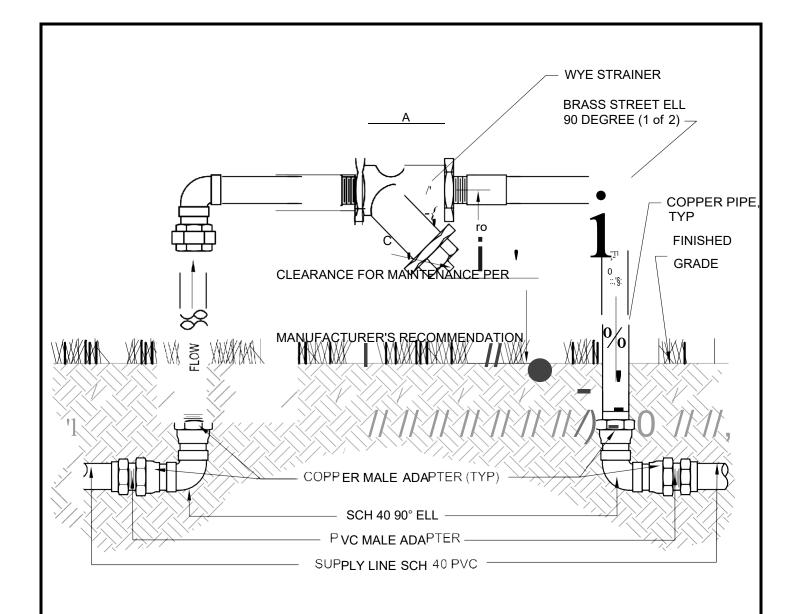



| Size | 1/2"  | 3/4"  | 1"    | 11⁄4"  | 1½"     | 2"  |
|------|-------|-------|-------|--------|---------|-----|
| Α    | 23/4" | 3"    | 3¾"   | 41/,5" | 413/45" | 6½" |
| В    | 21/4" | i ¾5" | 23/4" | 3%"    | 3½"     | 5½" |
| С    | 1/4"  | 3/4"  | 3/4"  | 3/4"   | 3/4"    | 1"  |
| Wt   | .75   | 1.38  | 2.13  | 3.13   | 4.5     | 7   |

- 1. BODY AND CAP SHALL BE BRONZE ASTM B62; SCREEN SHALL BE 20 MESH STAINLESS STEEL; GASKET SHALL BE NON-ASBESTOS; ENDS SHALL BE THREADED ANSI/ASME B1.20.1
- 2. WORKING PRESSURE SHALL BE NON-SHOCK, 200 PSI @ 150 DEGREES
- 3. REFER TO CITY STANDARD DETAIL LSD-14 FOR ALL MATERIALS

|                 |          |         | CI'        | ry of            |                | DATE APPROVED BY CITY COUNTY 12/13/1 |               |     |
|-----------------|----------|---------|------------|------------------|----------------|--------------------------------------|---------------|-----|
|                 |          |         |            | STANDARD DETAILS |                |                                      |               | 1   |
|                 |          |         |            |                  | ANDARD         | -                                    | 21 25         | /   |
| APPR            | REVISED  | DATE    | <u>IRR</u> | IGATION \        | <u>NYE STR</u> | <u> AINER</u>                        | Man Hug       | Les |
|                 | REVISION | S       |            |                  |                |                                      | CITY ENGINEER |     |
| FILE NO.        |          | SCALE   |            | DRAWN            | CHECKED        | DATE                                 | DWG NO.       |     |
| LSD-26.DWG 1" = |          | = 1'-0" | AK/MM/PM   | RER              | NOV. 2005      | LSD-26                               | 1 of 1        |     |

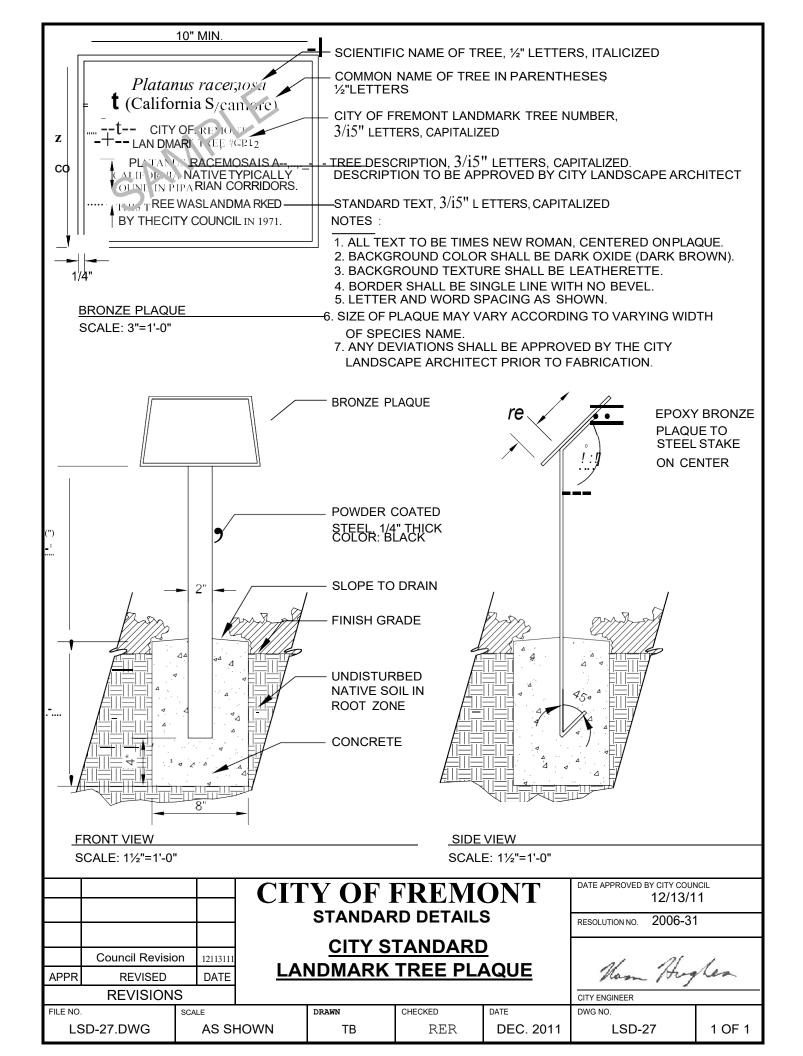

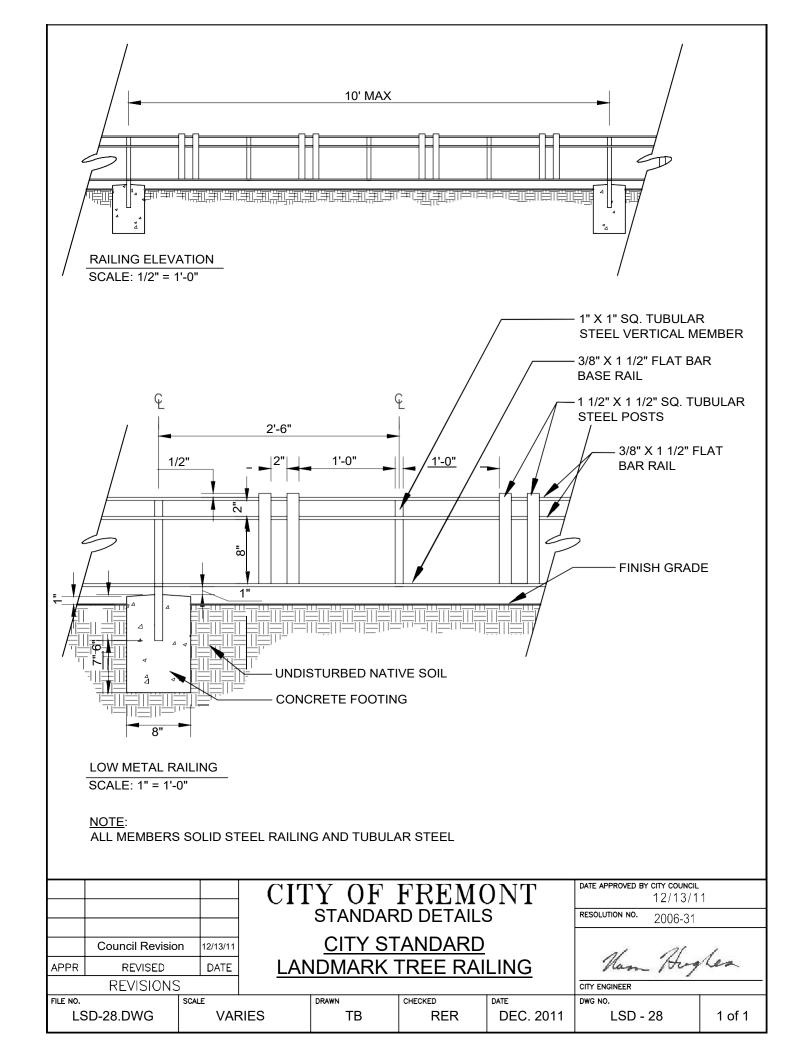

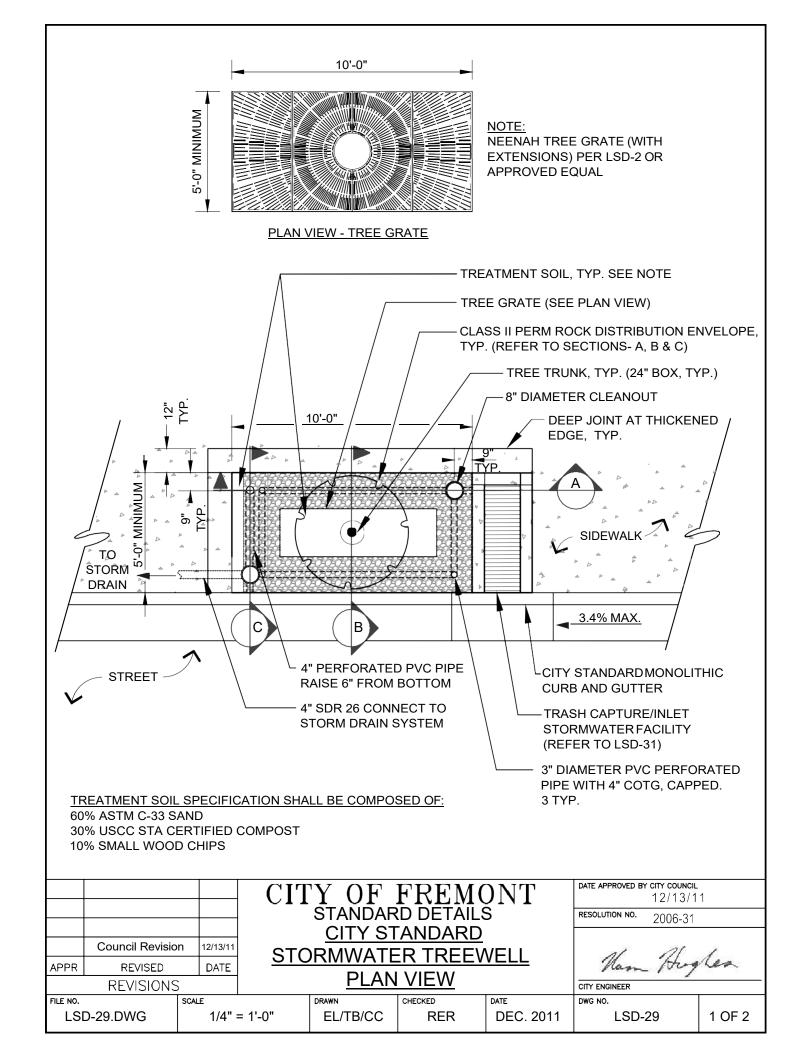

#### SIZING INFORMATION:


LSD-29.DWG

1/4=1'-0"

MAM/TB/CC

RER


- 1. THE MAXIMUM ALLOWABLE DRAINAGE AREA FOR THIS TREEWELL AS SHOWN (10' x 5') SHALL BE 1,250 SQ. FT. TREEWELL HAS BEEN SIZED USING THE COMBINED FLOW AND VOLUME METHODOLOGY AS DETAILED IN THE ACCWP C.3 STORMWATER TECHNICAL MANUAL. ANY DEVIATION FROM THIS SIZE (10' x 5') WOULD REQUIRE FLOW-VOLUME CALCULATIONS. SUBSURFACE TREEWELL TREATMENT DEVICES WILL NOT BE ACCEPTED USING SIMPLIFIED SIZING CRITERIA OF 4%.
- 2. THE CURB INLET OPENING OF 15" AS SHOWN IS SUFFICIENT TO CAPTURE 100% OF THE TREATMENT RUNOFF FROM THE MAXIMUM DRAINAGE AREA (1,250 SQ.FT. OF IMPERVIOUS AREA) PERTINENT TO THIS TREEWELL SIZE. THE LENGTH OF CURB OPENING REQUIRED FOR 100% CAPTURE IS DEPENDENT ON THE GUTTER SLOPE (FOR TREEWELLS INSTALLED AT GRADE). STREETS GREATER THAN 3.4% SHALL REQUIRE LONGER OR MULTIPLE CURB OPENINGS BASED ON INLET CAPTURE CALCULATIONS.

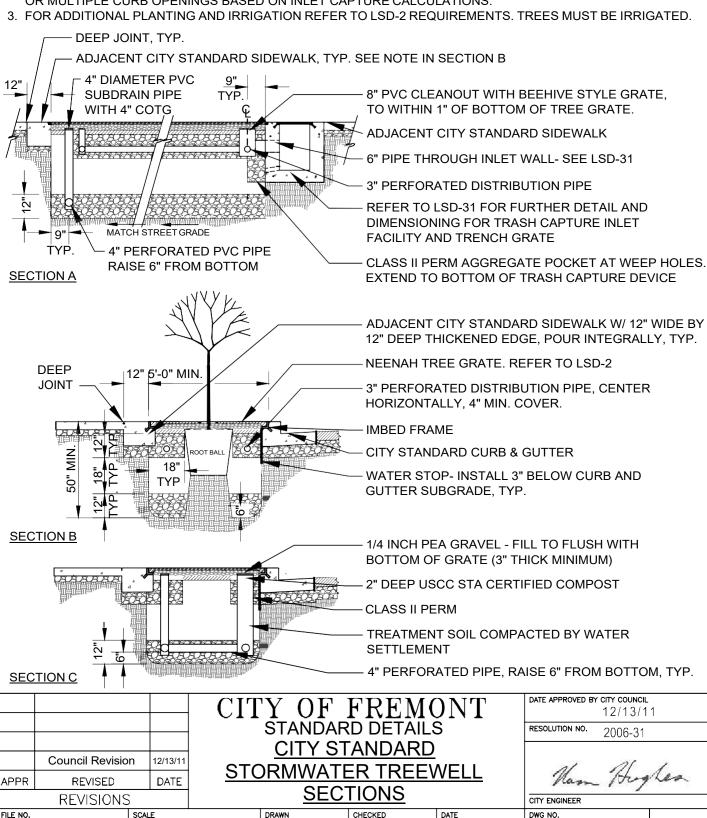



DEC. 2011

LSD-29

2 OF 2

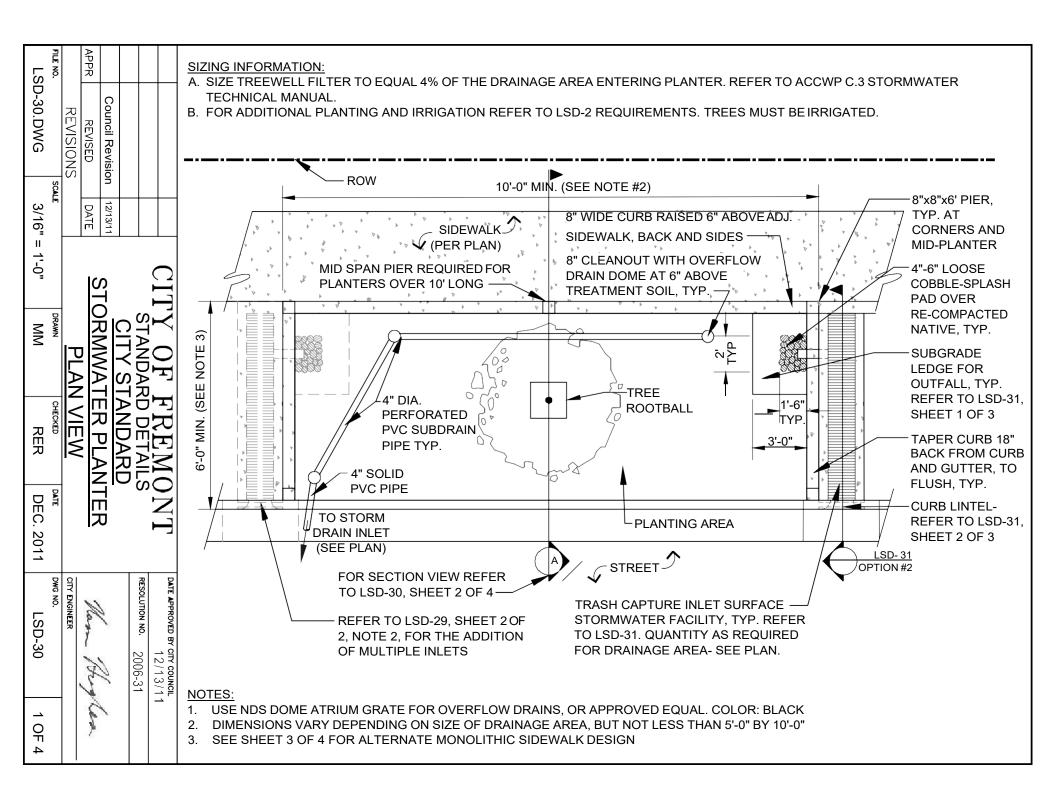

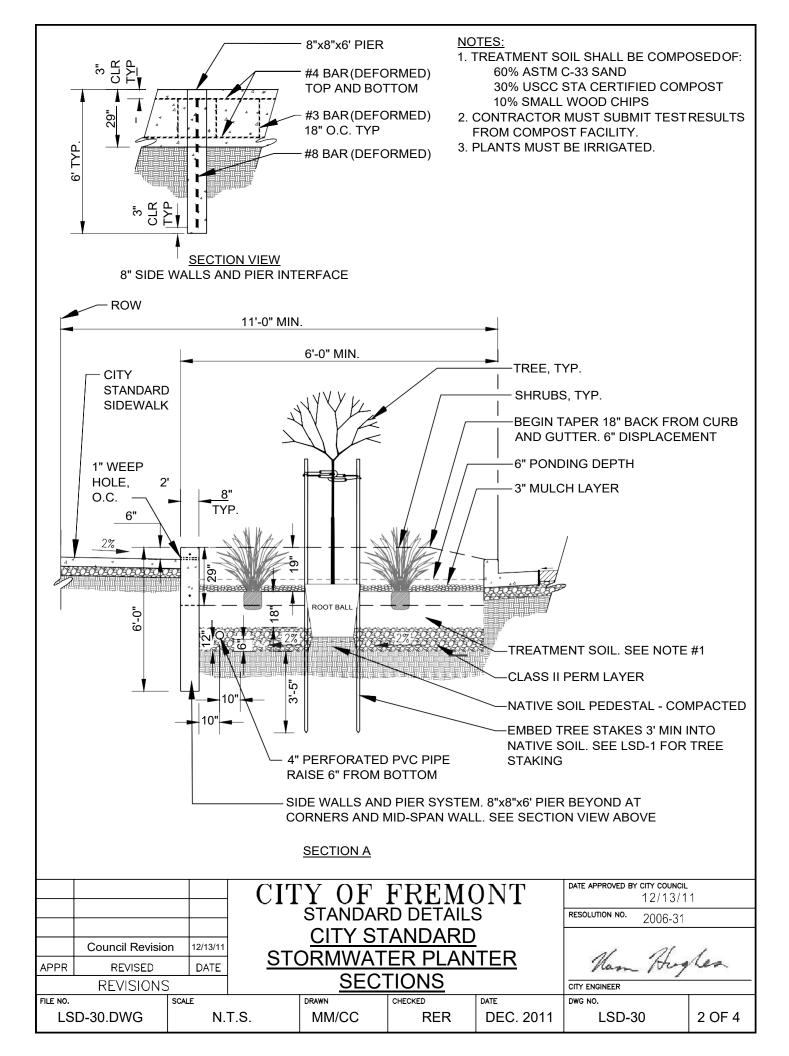

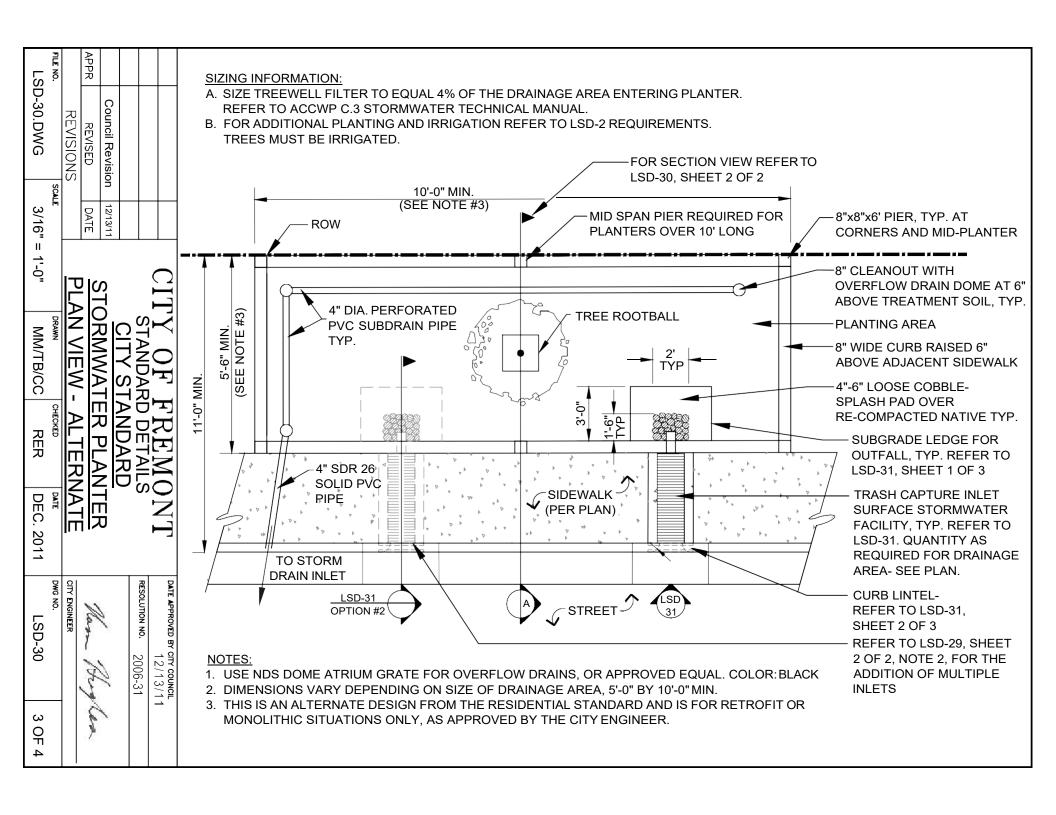

# NOTES: 1. TREATMENT SOIL SHALL BE COMPOSED OF: 60% ASTM C-33 SAND 30% USCC STA CERTIFIED COMPOST (SEE NOTE 2) 10% SMALL WOOD CHIPS 2. CONTRACTOR SHALL SUBMIT TEST RESULTS FROM 29" COMPOST FACILITY. 3. PLANTS MUST BE IRRIGATED. 4. THIS IS AN ALTERNATE DESIGN FROM THE RESIDENTIAL STANDARD AND IS FOR RETROFIT OR 9 MONOLITHIC SITUATIONS ONLY, AS APPROVED BY THE CITY ENGINEER. RIGHT OF WAY AT BACK OF WALL. WIDTH SHALL BE 11'-0" FROM FACE OF CURB TREE, 24" BOX, TYP. SHRUBS, TYP. 6" MIN. PONDING DEPTH 3" MULCH LAYER SIDE WALLS AND PIER SYSTEM. 5'-6" MIN. SEE DETAIL ABOVE TYP. CITY STANDARD SIDEWALK, CURB AND GUTTER ROOT BALL .0-.9 TREATMENT SOIL. SEE NOTE

8"x8"x6' PIER

18" O.C. TYP

**SECTION VIEW** 8" SIDE WALLS AND PIER INTERFACE

#4 BAR (DEFORMED)

#3 BAR (DEFORMED)

#8 BAR (DEFORMED)

TOP AND BOTTOM

SECTION A

4" PERFORATED PIPE RAISE 6" FROM BOTTOM

9" 10" 10"

TYP.

|          |                  |            | CIT  | CITY OF FREMONT    |                |           |               | CITY COUNCIL<br>12/13/1 | 1      |
|----------|------------------|------------|------|--------------------|----------------|-----------|---------------|-------------------------|--------|
|          |                  |            |      | STANDARD DETAILS   |                |           |               | 2006-31                 |        |
|          |                  |            |      | CITY ST            |                |           |               |                         |        |
|          | Council Revision | n 12/13/11 | CT/  |                    |                | TED       | 11            | 11                      | 1      |
| APPR     | REVISED          | DATE       |      | STORMWATER PLANTER |                |           | Nam           | Hug                     | Rea    |
|          | REVISIONS        |            |      | <u>CTIONS-</u>     | <u>ALTERNA</u> | ATE       | CITY ENGINEER |                         |        |
| FILE NO. |                  | SCALE      |      | DRAWN              | CHECKED        | DATE      | DWG NO.       |                         |        |
| LS       | LSD-30.DWG       |            | T.S. | PN/TB/CC           | RER            | DEC. 2011 | LSD-3         | 0                       | 4 OF 4 |


**CLASS II PERM LAYER** NATIVE SOIL PEDESTAL


MID-SPAN WALL.


8" x 8" x 6' PIER BEYOND AT CORNERS AND

SEE LSD-1 FOR TREE STAKING

EMBED TREE STAKES 3' MIN INTO NATIVE SOIL.

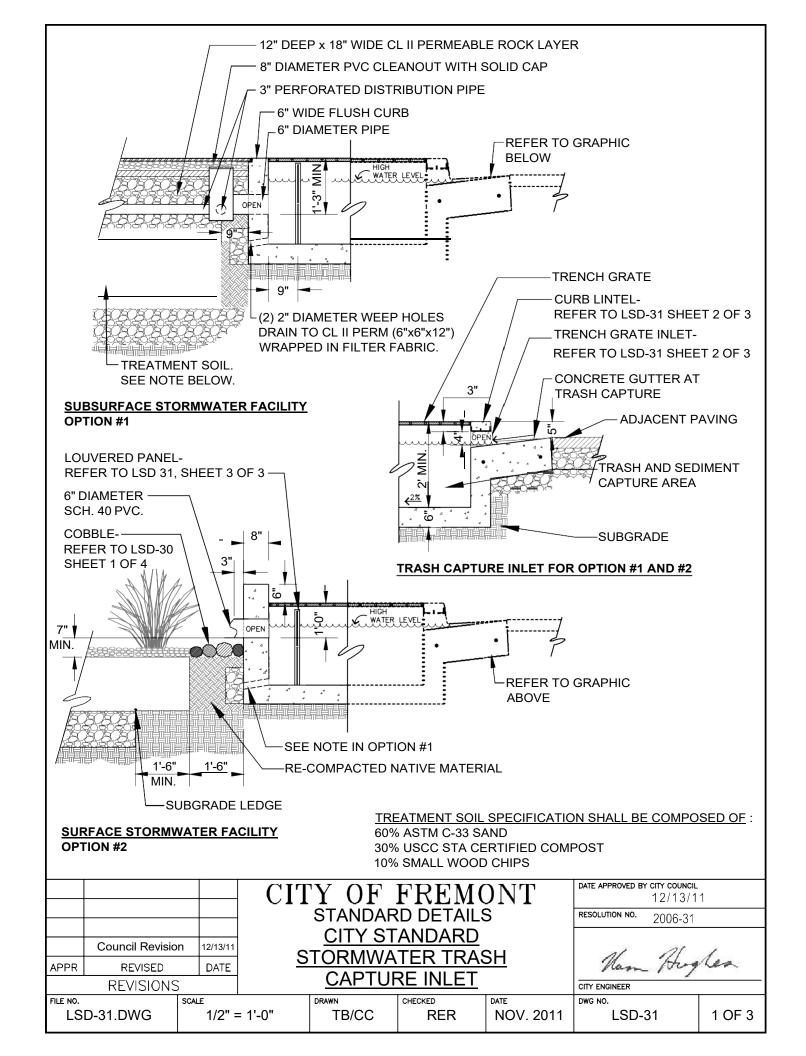


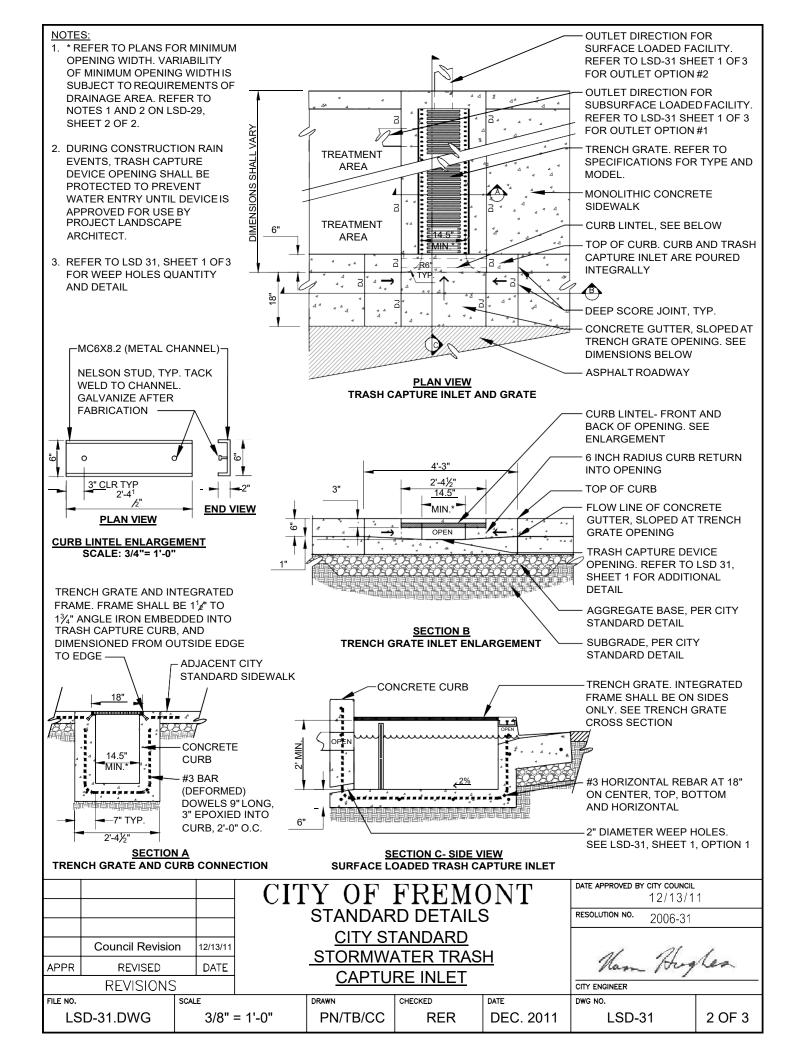

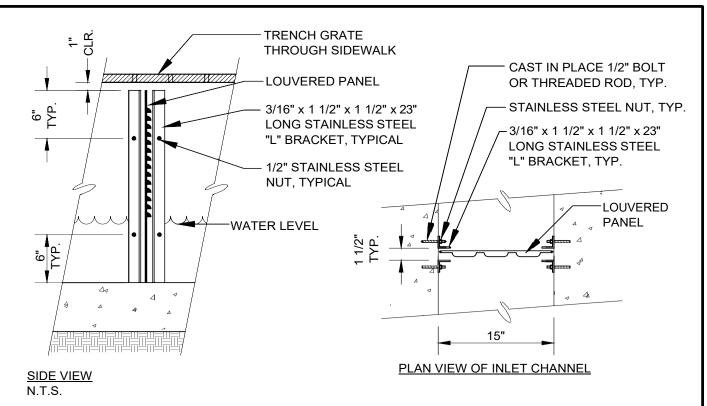

ACCEPTABLE LOUVERED PLATE AND BRACKET SUPPLIER, OR APPROVED EQUAL:

ROSCOE MOSS COMPANY TYPE 304 STAINLESS STEEL 4360 WORTH STREET LOS ANGELES, CA 90063 WWW.ROSCOEMOSS.COM

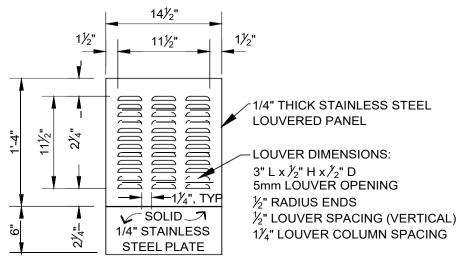

FRONT VIEW

- 1. LOUVERED PANEL MINIMUM DIMENSION: 22"H x 14 1/2"W x 1/4T". PANEL SIZES SHALL VARY DEPENDING UPON FACILITY REQUIREMENTS.
- 2. FIELD VERIFY AND MAINTAIN 1"CLEAR FROM BOTTOM OF TRENCH GRATE.

|          |                  |          | CITY (    | CITY OF FREMONT  |             |          |               | DATE APPROVED BY CITY COUNCIL 12/13/11 |        |  |  |
|----------|------------------|----------|-----------|------------------|-------------|----------|---------------|--|--------|--|--|
|          |                  |          | STAN      | STANDARD DETAILS |             |          |               | 2006-31                                |        |  |  |
|          |                  |          | CIT       | CITYSTANDARD     |             |          |               |  |        |  |  |
|          | Council Revision | 12/13/11 |           |                  |             |          |               | 11 11 1                                |        |  |  |
| APPR     | REVISED          | DATE     |           | STORMWATER TRASH |             |          |               |  | hea    |  |  |
|          | REVISIONS        |          | CA        | <u>PTURE INL</u> | <u>.ヒ I</u> |          | CITY ENGINEER |  |        |  |  |
| FILE NO. |                  | SCALE    | DRAWN     | CHECKED          | DATE        |          | DWG NO.       |  |        |  |  |
| LS       | LSD-31.DWG       |          | 1'-0" MAN | M/CC RER/M       | IM NC       | OV. 2011 | LSD-3         | 1                                      | 3 OF 3 |  |  |