

Landscape Development Requirements & Policies (LDRP)



Please note, the Water Efficient Landscape Ordinance (WELO) has been updated by the Department of Water Resources and has been adopted by the City of Fremont as of December 1, 2015. Please refer to https://water.ca.gov/Programs/Water-Use-And-Efficiency/Urban-Water-Use-Efficiency/Model-Water-Efficient-Landscape-Ordinance for additional information.

Updated: July 2022 Check on-line for the latest version at: https://city.fremont.gov/ldrp



FREMONT MUNICIPAL CODE SECTIONS:

FMC 18.215 (Tree Preservation)
FMC 18.235 (Design Review)
FMC 18.215 (Trees)
FMC 18.183.010 (Parking, Loading Areas and Vehicle Storage)
FIRE CODE

And

CITYWIDE DESIGN GUIDELINES (CDG)
NPDES PERMIT SECTION C.3
STATE WATER EFFICIENT LANDSCAPE ORDINANCE (WELO)
BAY FRIENDLY LANDSCAPE GUIDELINES (BFL)
CITY LANDSCAPE STANDARD DETAILS (LSD)



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Purpose of LDRP and Definitions

PURPOSE:

Who uses this document:

The Landscape Development Requirements and Policies (LDRP) is intended for the landscape architect preparing construction documents in the form of Building Permit or Improvement Plans, or in preparing preliminary design documents in the form of a Design Review application for review by the City of Fremont. Some items will require coordination with other disciplines such as civil engineer, planner, arborist or others.

What the document does:

The LDRP assembles most of the City of Fremont Council adopted landscape requirements, Regional and State landscape requirements, and Bay-Friendly Landscape requirements (BFL) into one easy to use checklist to assist the applicant/landscape architect when submitting for Building Permit or Improvement Plan approval. The checklist is not required at the time of planning entitlement review (Design Review), but it can assist the design team to develop a plan that will ultimately be subject to these requirements during detailed (construction documents) review. Standalone single-family residential home projects (with less than 500 square feet of landscape area) are not required to complete the checklist unless conditioned through a separate approval.

Why should this document be followed:

The primary reason to use this document is to accelerate the Building Permit and Improvement Plan review process so that applicants can move their project through City approval in the most efficient manner possible. Landscape projects that address all the applicable requirements accurately in their first submittal, along with the completed checklist, should be able to gain approval in 2 or 3 reviews (not withstanding other city permit requirements).

In addition to efficient plan reviews, this document can assist the design team to organize and coordinate the multiple landscape requirements and forms set out in the Fremont Municipal Code, State of California Water Efficient Landscape Ordinance (WELO), Municipal Regional National Pollution Discharge Elimination System Permit Provision C.3 (C.3), City Tree Preservation Ordinance, Bay-Friendly Landscape (BFL) practices, Citywide Design Guidelines (CDG) and other outside agency policies.

DEFINITIONS:

Bay-Friendly Landscape (BFL):

Bay-Friendly Landscape is a holistic approach to the design and maintenance of landscape to support the integrity of the San Francisco Bay watershed through best practices such as designs that include, but are not limited to, strong harmony with the native and natural conditions, reduced waste, reduced runoff, integrated pest management, improved healthy soils with less fertilizers, and water conservation measures. Fremont encourages all landscapes to achieve this goal, but at a minimum, the three required Bay Friendly practices not included in WELO 2015 must be met. (See Planting section of checklist.) Council adopted the requirement in Resolution 2012-34.



WELO:

WELO is the acronym for **Water Efficient Landscape Ordinance**. On December 1, 2015 the State of California revision to WELO became effective for new construction projects with total landscape area equal to or greater than 500 square feet in size and rehabilitated landscape projects with total landscape area of 2,500 square feet or larger. The City of Fremont is required to enforce the State Ordinance through the Building Permit plan review process. WELO establishes many landscape and irrigation water conservation techniques which are included here in this Document. To review the full State Ordinance, visit: https://water.ca.gov/Programs/Water-Use-And-Efficiency/Urban-Water-Use-Efficiency/Model-Water-Efficient-Landscape-Ordinance

In summary, WELO applies to the following project types that require building permit or improvement plan review and approval:

- a. New construction projects with total landscape area equal to or greater than 500 square feet in size.
- b. Rehabilitated landscape projects with total landscape area of 2,500 square feet or larger.

Tree Survey Requirements:

The City regulates the removal and destruction of existing trees to preserve the visual beauty that trees provide to the residents and visitors; environmental benefit they provide, such as reducing heat buildup and controlling wind and erosion; and their contribution to property values. Trees have value as individual trees, as groups of trees, and as components of the overall urban forest. To the extent that trees are contributing in these ways to the public welfare of the people of the City of Fremont, trees are protected and preserved through the regulation of their removal and damage to them. The complete Tree Preservation Ordinance is available online at https://city.fremont.gov/treepreservationordinance.

Fremont Municipal Code (FMC):

The City Council enacts ordinances that influence and regulate development in Fremont. The citations to the FMC in the checklist are referring to the Zoning code, Tree Preservation code, or Subdivision code. The full Fremont Municipal Code is available for view at: www.fremont.gov/fmc.

Use of Landscape Standard Details (LSDs):

The Landscape Standard Details referenced in the LDRP, and included at the end of this package, must be used for City of Fremont projects, on City of Fremont property, and within City of Fremont rights-of-way. These details are not required for private property landscapes, but are available for use.

Citywide Design Guidelines (CDG) and other Design Guidelines:

The City Council adopted Citywide Design Guidelines to complement its Design Review permitting process (FMC 18.235). The Citywide Design Guidelines contain both "Rules" and "Guidelines." The Rules are mandatory regulations that must be satisfied when applicable. The Guidelines are used to encourage the highest level of design quality while at the same time providing flexibility necessary to encourage creativity on the part of the project designers. Citations to the citywide and other area specific design guidelines are available online at https://city.fremont.gov/citywidedesignguidelines.

Municipal Regional National Pollution Discharge Elimination System Permit Provision C.3 (C.3):

The new Municipal Regional National Pollutant Discharge Elimination System Permit (also known as the MRP), issued by the San Francisco Regional Water Quality Control Board, regulates stormwater pollution. The MRP requires 70+ municipalities in the Bay Area, including the City of Fremont, to place conditions on development projects to incorporate site design measures, source controls, treatment measures, and for larger projects, flow duration controls. Permit provision C.3, titled New Development and Redevelopment, gives local responsibility to include low impact development (LID) techniques on projects. The LDRP Checklist is limited to landscape-based LID solutions and coordination of those solutions with other City requirements. The complete City stormwater requirements are available online at https://city.fremont.gov/stormwaterpermit.



Items Required with Landscape Plan Submittal

DELIVERABLES by SUBMITTAL STAGE	FORMAT	REFERENCE
A. Entitlement (Design Review):		
1 Landscape Plan (Conceptual Planting and Site Plan)	Plan set	WELO / FMC / BFL
Preliminary Landscape-based Stormwater Treatment Plan	Plan set	C.3
Tree Survey/Tree Preservation Plan and Tree Species Table	Plan set	FMC
B. Building Permit or Improvement Plan Review (Construction Documents):	01/ 44	Oit of Francisch as a visual
Landscape Plan Checklist (see page 5 of this document)	8½ x 11	City of Fremont required
Water Efficient Landscape Worksheet	8½ x 11	WELO, See Form A
Soil Management Report	8½ x 11	WELO
Tree Survey/Tree Preservation Plan and Tree Species Table (may be combined with Demolition Plan or Grading Plan as appropriate)	Plan set	FMC
Grading Plan (may be prepared by civil engineer).	Plan set	WELO Section 492.8
Planting Plan	Plan set	FMC / WELO Section 492.
Hydrozone Plan with Hydrozone Table	Plan set	WELO, See Form A
Irrigation Plan	Plan set	FMC / WELO Section 492.
C. Project Completion (Prior to Construction Sign-off and Occupancy):		
Certificate of Completion by Property Owner	8½ x 11	WELO, See Form B, Part
Certification of Installation by Landscape Architect - According to the Landscape Documentation Package (WELO)	8½ x 11	WELO, See Form B, Part 2
Irrigation Schedule	8½ x 11	WELO, See Form B, Part
Schedule of Landscape and Irrigation Maintenance	8½ x 11	WELO, See Form B, Part 2
Landscape Irrigation Audit Report (Not required if using Form C)	8½ x 11	WELO, See Form B, Part



Landscape Plan Checklist

(Submit with Building Permit and/or Improvement Plan Construction Documents)

ect Na	ame:_		<u> </u>
N" Nu	ımber	(Bldg.	Permit) or Tract Number (Improvement Plan):
dscap	e Arcl	nitect &	& Firm:
Licens	se Nur	nber: _	Phone Number:
Subr	nit the	follov	ving checklist with First Plan Submittal. Check boxes as they apply.
Incomplete	Not Applicable		
		A.	GENERAL PROJECT AND SUBMITTAL INFORMATION REQUIRED:
		1.	Plans are prepared on accurately surveyed site plan(s) to appropriate scale.
			Reference: FMC 18.235, CDG (Design Development)
		2.	Plans include north arrow, graphic and written scale, property lines, street names, and accurate right of way.
			Reference: FMC 18.235, CDG (Design Development)
		3.	Plans show existing and proposed features.
			 Plans show existing and proposed buildings, trees, structures, walls, fences, utilities, meters, paved areas, and other site improvements. Plans show location of all existing and proposed landscape and streettrees including a complete keyed plant list showing quantities, container sizes, and correct botanical designations of all landscape materials. Plans include design details for landscape architectural features such as walls, fences, lighting, paving types, arbors, benches, fountains and other features; and complete irrigation plans. References: FMC 18.70.060 and 18.235
	N" Nu dscape Licens Subr	N" Number dscape Arch License Num Submit the	N" Number (Bldg. dscape Architect & License Number: _ Submit the follow A. 1.

Checklist Legend:



□ □ 4. Plans and calculations are prepared by a Landscape Architect.

Requirement: Plans are stamped electronically or otherwise with a valid State of California Landscape Architect's license/stamp including registration number and expiration. Signature required on final set at time of permit issuance.

Reference: FMC 18.205.110. State Business and Professions Code

WELO:

BFL:



Not Applicable ncomplete В. SITE LAYOUT REQUIREMENTS: 1. Parking lot trees – interior. Requirement: The plans show one large canopy tree for every 10 parking stalls. Trees shall be evenly distributed throughout the internal field of the parking lot. Large canopy trees can be substituted with medium sized canopy trees if spaced every 6 parking stalls to meet the intent of shading the parking lot. Note: See LSD-6 and Planting Requirements for definition of "large" and "medium" trees. Reference: FMC 18.183.110, CDG 3.81G 2. Parking lot trees – perimeter. Requirement: The plans show one (1) screen or canopy tree for every three (3) parking stalls between the parking lot and property line, when those stalls are adjacent to the property Reference: FMC 18.183.110, CDG 3.81G 3. Parking lot – screening from street. Requirement: Parking areas within 50 feet of a public street are screened with one of the (CHECK ONE OR MORE): following: three (3) foot tall masonry wall, three (3) foot tall berm, or a continuous shrub planting of 5 gallon plants that will grow to a minimum three (3) Note: Downtown and other urban districts and settings may be governed by different requirements. Reference: FMC 18.183.110 П Access & circulation, linkages/paving & amenities. 4. Requirement: Durable decorative paving shall be used at crosswalks within a project and when paved areas serve multiple purposes such as when walks or recreational amenities coincide with driving areas. The path of travel from the street, sidewalk, parking areas and bus stops to the building entrances and key areas within the site shall be easily identifiable. Reference: CDG 3.7R through 3.11R 5. Minimize hardscape. Requirement: Minimize hardscape to reduce heat gain and reduce stormwater runoff. Consider use of permeable pavers in areas with good drainage. **Reference:** CDG 2.1R, 2.4R

Checklist Legend:

LSD: City Landscape Standard Detail WELO: State Water Efficient Landscape Ordinance FMC: Fremont Municipal Code
C.3: NPDES Regional Permit BFL: Qualifies for Bay-Friendly Landscape CDG: Citywide Design Guidelines



	6.	Tree planters – minimum size.
		Requirement: Tree planters shall be maximum size feasible to benefit tree growth and provide separation from infrastructure and adjacent paving, curbs, walls, etc. Minimum planter size for trees shall have an interior dimension of six feet in any direction and have no less than 48 square feet of soil surface area overall, which is free of any inorganic material such as utilities, fire hydrants, light poles, signs, subterranean vaults, etc. (hint: an inside planter dimension of 6'x8' is 48 square feet and will fit between two parking stalls.) Note: Urban tree grate installations are exempt and are governed by LSD-2. Reference: FMC 18.183.110, CDG 3.77R
	7.	Play area design complies with the Consumer Product Safety Commission (CPSC) guidelines and American Society for Testing And Materials (ASTM).
		Requirement: Plans identify safety protection zone(s), Plans identify manufacturer and model numbers Plans include a note requiring contractor to submit a letter prepared by a Certified Playground Inspector certifying that the installed play area is in compliance with ASTM 1487 and CPSC guidelines. The letter shall confirm the manner in which the assembly and installation of playground equipment complies with the requirements.
	8.	Pedestrian links between buildings and street provided.
		Requirement: Visually distinct pedestrian walkways shall be provided that link buildings to other buildings, and buildings to street sidewalks. Reference: CDG 3.9R
	9.	Wetband firebreak provided adjacent to fire areas.
		 Requirement: For projects in hillside fire areas adjacent to open space or undeveloped land a wetband is required as follows: A labeled and dimensioned 30-foot wide irrigated or paved protection zone between structure and open space along rear of property. Minimum planting is low growing fire-resistant groundcover or grass. High canopy trees may not be closer than 10 feet to any other mature canopy or structure. Hardscape surfaces and pools may be in Wetband. Large understory shrubs and auxiliary structures are not allowed. Reference: FMC Fire Code

Checklist Legend:



Not Applicable ncomplete C. PLANTING REQUIREMENTS: П 1. Street trees required. **Requirement:** Street trees are shown at 24 inch box size and planted within the right of way in front of the each parcel. Street tree placement complies with spacing requirements and distance from utilities as identified in City Standard Detail, LSD-5. Compliance with planting requirements identified in City Standard Details, LSD-1 and LSD-2 is required. Reference: CDG 2.50R, 2.53R, 3.77R, LSD 2. Bark mulch required to three inch depth. Requirement: Include a note on plans that three inches of shredded (walk-on) bark mulch is required for all non-sod planting areas. Shredded bark mulch is required in stormwater treatment areas; however, recycled, painted, or dyed mulch is prohibited in stormwater treatment areas. Note: "Gorilla hair" mulch is prohibited. Mulch is not a substitute for landscape planting. Reference: WELO, BFL, LSD 3. Compost incorporated at a minimum of four cubic yards per 1,000 square feet. Requirement: Soil amendments shall be incorporated according to recommendations of the soil report. On engineered slopes, only amended planting holes require amendment. Soils with greater than six percent organic matter in the top six inches of soil are exempt from adding compost. Reference: BFL, WELO П 4. Trees meet minimum spacing from buildings and utilities. Requirement: Plans show trees with the following minimum clearances to buildings or other built features: Small trees (to 15 feet tall) and columnar trees (to 12' wide) no closer than 6 feet from building or 2 feet from paving, curbs, or walls with a minimum planting area 5 feet wide. Medium trees (to 35 feet tall) no closer than 10 feet from building or 3 feet from paving, curbs, or walls with a minimum planting area 6 feet wide. Large trees (above 35 feet tall) no closer than 15 feet from building or 3 feet from paving, curbs, or walls with a minimum planting area 6 feet wide, preferably 8 feet wide. [LSD-6] Refer to City Standard Detail LSD-5 for required spacing from utilities. Reference: LSD, CDG 3.77R

Checklist Legend:

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	5.	Plants meet minimum size requirements.
		Requirement: All plants meet the following minimum size standards: Trees are 15 gallon or larger, except street trees, which are minimum 24 inch box. Shrubs and groundcover plants are minimum 1 gallon size. Forty percent of all shrubs and groundcover must be 5 gallon size or larger. Reference: FMC 18.50.050(E), 18.183.110 & 18.215.080
	6.	City standards for work in right of way or public property.
		Requirement: All landscape work shown in City right of way or City owned property/easements comply with City of Fremont Landscape Standard Details. Reference: LSD
	7.	Restrictions on the use of turf.
		 Requirement: Turf is limited to no more than 25 percent of the total planted area on the project, as long as the water budget is met. <i>Note: Use of turf is strongly discouraged to promote water conservation.</i> Reference: WELO, BFL Requirement: Turf is prohibited in medians. Reference: WELO Requirement: Turf is not used on slopes greater than 4:1 Reference: WELO
	8.	Select water conserving plants and turf species.
		Requirement: Plant List (table/legend) shown on plans shall include the Water Use Classification of Landscape Species (WUCOLS) designation or designation from horticultural researchers with academic or professional associations for the selected species, the spacing for shrub and groundcover species, and the quantity of each plant used. Note: Use of medium and high water plants is strongly discouraged to promoted water conservation. Reference: WELO
	9.	Choose and locate plants to grow to natural size and avoid shearing.
		Requirement: No plant species will require shearing. Select species and spacing to allow plants to grow to natural size and shape without shearing at any point in the lifespan of the plant excluding structural and regular maintenance pruning. Plant spacing shall not allow plants to grow into adjacent buildings, sidewalks, roadways, or adjacent landscape areas. Reference: Bay-Friendly Scorecard item E.1.a, City Council Resolution 2012-34.
	10.	Do not plant invasive plant species. Requirement: None of the plant species listed by CA-IPC as invasive in the San Francisco Bay Area are included in the planting design. Reference: Bay-Friendly Scorecard item E.2.a, City Council Resolution 2012-34.

Checklist Legend:

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Complete	Incomplete	Not Applicable		
			D.	TREE PRESERVATION REQUIREMENTS [FMC 18.215.120]
			1.	Tree survey meets minimum plan standards.
				 Existing and proposed site features, including but not limited to buildings, walls, paving, grading, etc. Tree(s) with six inch DBH (trunk diameter at 4.5 feet above ground level) and larger are located on plan by a licensed surveyor. Tree trunks must be represented with an accurately scaled dot to show the true bulk of the DBH. Tree canopies must be accurately delineated. Trees are labeled by number on the plan and tagged on-site per ISA standards. Tree Survey Plan includes a summary table identifying botanical designation, DBH, and elevation of each tree at ground level. Note: Tree Survey information may be incorporated into a topographic survey or other project plan, provided all the required information is included. If no trees exist on site, provide a statement by the civil engineer, landscape architect or surveyor indicating this, in lieu of the required tree survey. Reference: FMC 18.215.120 Sample Plan: See the sample Tree Survey on page 24.
			2.	Tree survey is incorporated into other plans. Project plans clearly show which trees are proposed for preservation and which trees are proposed for removal. Trees for removal and preservation are shown on ALL the following project (construction) plans: • Show trees for removal and preservation on the following plans: • Grading Plan • Demolition Plan • Show trees for preservation (only) on the following plans: • Planting Plan • Irrigation Plan • Underground Utility Plans and Joint Trench Plan
			3.	Tree protection fencing shown on plans. Requirement: Trees designated for preservation comply with City of Fremont Standard Detail: "Tree Protection Fencing," LSD-9, or other tree specific City approved tree protection measures prepared by a International Society of Arboriculture (ISA) Certified Arborist or American Society of Consulting Arborist (ASCA) member in good standing. Reference: LSD

Checklist Legend:

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C.3: NPDES Regional Permit BFL: Qualifies for Bay-Friendly Landscape CDG: Citywide Design Guidelines



Not Applicable ncomplete E. **IRRIGATION REQUIREMENTS:** 1. П Meters and valves. Requirement: Plans show location and size of all meters and submeters, points of connection, pumps, isolation valves and remote control valves. Irrigation must be on a dedicated meter or submeter for non-residential projects 1,000 square feet and greater and residential projects 5,000 square feet and greater. Reference: WELO 2. Master shut-off valves. Requirement: Plans show locations and types of all master shut-off valves. Landscapes that make use of technologies that allow for the individual control of sprinklers that are individually pressurized in a system equipped with low pressure shut down features are excepted. Reference: WELO 3. Flow sensors. Requirement: Plans show flow sensors that detect high flow conditions created by system damage for all non-residential landscapes and residential landscapes of 5,000 square feet and larger. Reference: WELO Operating pressure and GPM. 4. Requirement: Maximum GPM (Gallons Per Minute) demand and minimum operating pressure for each point of connection is clearly shown on plan along with the GPM demand for each valve. If the water pressure is below or exceeds the recommended pressure of the specified devices, the installation of a pressure regulating device is required. Reference: WELO, BFL 5. Pipes and sleeves. Requirement: Plans show size and location of all pipes including sleeves for the irrigation system. The following minimum requirements are shown on the plans: All lateral lines shall have 12" cover. П All main lines shall have 18" cover. All main lines and wiring under pavement shall be sleeved with 24" cover.

Checklist Legend:

LSD: City Landscape Standard Detail WELO: State Water Efficient Landscape Ordinance FMC: Fremont Municipal Code
C.3: NPDES Regional Permit BFL: Qualifies for Bay-Friendly Landscape CDG: Citywide Design Guidelines


All lateral lines under pavement shall be sleeved with 18" cover.



Complete	Incomplete	Not Applicable		
			6.	Hose bibs and quick couplers. Requirement: Plans show location and type of all hose bibs and quick couplers.
				Reference: WELO
			7.	Weather-based controller.
				Requirement: Plans show location and type of weather-based controller, which relies on soil moisture sensor, rain gauge or other weather-based controlling device. Reference: WELO, BFL
			8.	Backflow prevention device.
				Requirement: A Reduced Pressure Backflow Prevention Device (with enclosure) of the same size as the meter shall be installed at every irrigation meter on the project. The model and installation of the Backflow Prevention Unit is subject to approval from the Alameda County Water District. A weather blanket shall be installed on all backflow prevention devices. Use LSD-16 and LSD-17 for irrigation on City of Fremont property and rights-of-way. Reference: WELO
			9.	Design details included.
				Requirement: Irrigation installation details shall be shown on plans to demonstrate compliance with these irrigation requirements. Use City of Fremont irrigation Landscape Standard Details (LSDs) for areas on City property or rights-of-way.
			10.	All irrigation equipment must meet ANSI and ASABE/ICC802-2014 standards.
				Requirement: All irrigation equipment must meet American National Standards Institute (ANSI), American Society of Agricultural and Biological Engineers/ International Code Council (ASABE/ICC)802-2014. "Landscape Irrigation Sprinkler and Emitter Standard. All sprinkler heads installed in the landscape must document a distribution uniformity low quarter of .65 or higher using the protocol defined in ASABE/ICC 802-2014. Reference: WELO
			11.	Irrigate trees separately.
				Requirement: All trees are irrigated by individual bubblers on an irrigation circuit isolated from the main system by a remote control valve. Reference: WELO

Checklist Legend:

LSD: City Landscape Standard Detail WELO: State Water Efficient Landscape Ordinance FMC: Fremont Municipal Code
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15. Alternative Prescriptive Compliance method.
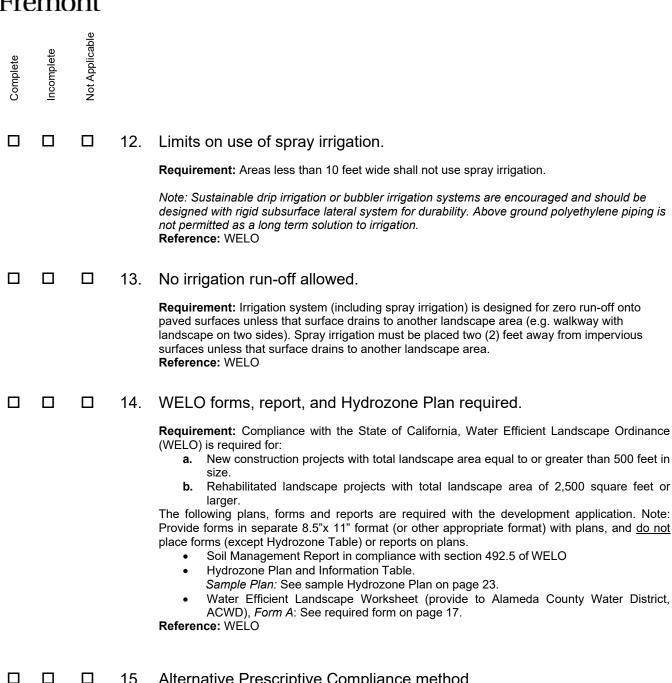
> Requirement: The Prescriptive Compliance Requirements may be used as a compliance option to WELO for landscapes with total landscape area of 500 sf to 2,500 sf. Compliance with the entire list, Form C, is mandatory and must be documented on a landscape plan in order to use the prescriptive compliance option. Submit completed Form C with landscape plan. Pages 21-22. Reference: WELO

Checklist Legend:



	16.	Separated irrigation system required for City property, easements, and Homeowner Association managed common areas.
		Requirement: Back-up landscape or any landscape that will be maintained or owned by the City has a separate meter, backflow prevention device and controller compliant with City Standard Details. Reference: WELO, LSD
	17.	Include a note on the plans requiring submittal of the Certificates of Completion and Installation and all related documents (Irrigation Scheduling, Schedule of Landscape and Irrigation Maintenance, Landscape Irrigation Audit Report, and Soil Management Report) upon completion of construction, prior to project acceptance.
		Requirement: Completion and installation of WELO-compliant landscape and irrigation must be documented via the WELO/LDRP forms. Forms must be signed by the property owner, landscape contractor, and the project landscape architect. Forms are described below. Reference: WELO, LSD
	18.	Post construction signoff by project landscape architect and owner.
		Requirement: The following documents and certifications are required before final occupancy from the Building Official during construction to comply with WELO. Provide forms in separate 8.5" by 11" format (or other appropriate format) with plans. Do not place forms on plans. Note: The Project Landscape Architect should anticipate inspection during construction to support separate written certifications from him or her, that the installed and completed project complies with the City of Fremont Approved Plans, and complies with the WELO requirements as documented in the plans. • Certificate of Completion signed by property owner, Form B, Part 1: See required form, page 19. • Certificate of Installation signed by the Project Landscape Architect, AND the Project (Licensed) Landscape Contractor. Form B, Part 2: See required form, page 20. • Irrigation Scheduling Form B, Part 3: See required attachment, page 20. • Schedule of Landscape and Irrigation Maintenance, Form B, Part 4: See required attachment, page 20. • Landscape Irrigation Audit Report, Form B, Part 5: See required attachment, page 20. • Soil Management Report, Form B, Part 6: See required attachment, page 20.
		Prescriptive Compliance Checklist,

Checklist Legend:

LSD: City Landscape Standard Detail NPDES Regional Permit

WELO: BFL:

Reference: WELO

State Water Efficient Landscape Ordinance Qualifies for Bay-Friendly Landscape

Form C: See required form, pages 21-22.

Form B, Parts 1, 2, 3, 4, and 6: See required forms, pages 19-20.

FMC: CDG: Fremont Municipal Code Citywide Design Guidelines



Complete
Incomplete
Not Applicable

F. STORMWATER (LANDSCAPE-BASED) REQUIREMENTS: П 1. Design of landscape-based stormwater treatment complies with City Standards. Requirement: The design of stormwater treatment in the right of way complies with City Landscape Standard Details and the Municipal Regional National Pollution Discharge Elimination System Permit Provision C.3 requirements. The City details show options that include a tree well filter and a stormwater planter for use in the right of way. Trash Capture Devices are required upstream of planter with treatment soil in the right of way. Note: The handbook is available on the Alameda Countywide Clean Water Program website at: http://www.cleanwaterprogram.org/businesses_developers.htm, and City of Fremont Stormwater requirements at https://city.fremont.gov/stormwaterpermit. Reference: LSD, C.3 2 Plans show specifications for treatment soil. Requirement: Plans show soil specifications in compliance with the Alameda Countywide Clean Water Program C.3 Technical Guide when treatment soil is used on projects. Reference: C.3, BFL 3. Plans delineate treatment areas. Requirement: Plans clearly delineate where landscape based stormwater design features are located throughout the site. Place curb or header around landscape-based stormwater features for easy identification when combined with or adjacent to non-stormwater landscape.

~ End of Landscape Plan Checklist ~

Checklist Legend:

Reference: C.3



LDRP Form A: Water Efficient Landscape Worksheet

This form is equivalent to the MVVELO Appendix B Worksheet and	must be submitted with the Landscape Documentation Package.
Project Name:	PLN #:

Reference Ev	apotranspira	ation (ETo)		ı			
Hydrozone # /Planting Description ^a	Plant Factor (PF)	Irrigation Method ^b	Irrigation Efficiency (IE) ^c	ETAF (PF/IE)	Landscape Area (sq, ft,)	ETAF x Area	Estimated Total Water Use (ETWU) ^e
Regular Landscap	oe Areas						
				Totals	(A)	(B)	
Special Landscap	e Areas						
				1			
				1			
				1			
				Totals	(C)	(D)	
				•	,	ETWU Total	
			Maxi	mum Allowed	Water Allowa	nce (MAWA)e	

^aHydrozone #/Planting Description

E.g

- 1.) front lawn
- 2.) low water use plantings
- 3.) medium water use planting

^b**Irrigation Method** overhead spray or drip

^cIrrigation Efficiency 0.75 for spray head 0.81 for drip ^dETWU (Annual Gallons Required) = Eto x 0.62 x ETAF x Area

where 0.62 is a conversion factor that converts acre-inches per acre per year to gallons per square foot per year.

^eMAWA (Annual Gallons Allowed) = (Eto) (0.62) [(ETAF x LA) + ((1-ETAF) x SLA)]

where 0.62 is a conversion factor that converts acre-inches per acre per year to gallons per square foot per year, LA is the total landscape area in square feet, SLA is the total special landscape area in square feet, and ETAF is 0.55 for residential areas and 0.45 for non-residential areas.

ETAF Calculations

Regular Landscape Areas

Total ETAF x Area	(B)
Total Area	(A)
Average ETAF	B÷A

All Landscape Areas

Sitewide ETAF	(B+D) ÷ (A+C)
Total Area	(A+C)
Total ETAF x Area	(B+D)

Average ETAF for Regular Landscape Areas must be 0.55 or below for residential areas, and 0.45 or below for non-residential areas.



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LDRP Form B, Part 1: Certificate of Completion This certificate is equivalent to the MWELO Appendix C (Part 1) certificate and is to be filled out by the project applicant upon completion of the landscape project.

Project Name:		PLN #:			
	ROJECT INFORMATION	ON SHEET			
Date					
Project Name					
Name of Project Applican	t	Telephone No.			
		Fax No.			
Title		Email Address			
Company		Street Address			
City		State	Zip Code		
Project Address	and Location:				
Street Address	and Education.	Parcel, tract or lot number, if availal	ole.		
City		Latitude/Longitude (optional)			
State	Zip Code	_			
	or his/her designee:				
Name		Telephone No.			
		Fax No.			
Title		Email Address			
Company		Street Address			
City		State	Zip Code		
Package and the Ce	rtificate of Completion and	all the documents within the La d that it is our responsibility to s and Irrigation Maintenance So	see that the project is		
Property Owner Sign	nature		Date		
2. Date the Landso3. Date that a copy	cape Documentation Pack cape Documentation Pack	age was submitted to the local age was approved by the local adscape Worksheet (including ter purveyor	agency		



LDRP Form B, Part 2: Certificate of Installation According to the Landscape Documentation Package

This certificate is equivalent to the second page of the MWELO Appendix C (Part 2) certificate and is to be filled out by the project applicant upon completion of the landscape project.

PART 2. CERTIFICATION OF INSTALLATION ACCORDING TO THE LANDSCAPE DOCUMENTATION PACKAGE

"I/we certify that based upon periodic site observations, the work has been substantially completed in accordance with the ordinance and that the landscape planting and irrigation installation conform with the criteria and specifications of the approved Landscape Documentation Package."

Signature of Landscape Contractor:	Date	
Name (print)	Telephone No.	
rtamo (print)	relephene rie.	
Title	Email Address	
License No. or Certification No.		
Company	Street Address	
Company .	0.000771441.000	
City	State	Zip Code
Signature of Landscape Architect:	Date	
Signature of Landscape Architect.	Date	
Name (print)	Telephone No.	
Title	Email Address	
Title	Linaii Addiess	
License No.	1	
Company	Street Address	
City	State	Zip Code
,		,

PART 3. IRRIGATION SCHEDULING

Attach parameters for setting the irrigation schedule on controller per ordinance Section 492.10.

PART 4. SCHEDULE OF LANDSCAPE AND IRRIGATION MAINTENANCE

Attach schedule of Landscape and Irrigation Maintenance per ordinance Section 492.11.

PART 5. LANDSCAPE IRRIGATION AUDIT REPORT

Attach Landscape Irrigation Audit Report per ordinance Section 492.12.

PART 6. SOIL MANAGEMENT REPORT

Attach soil analysis report, if not previously submitted with the Landscape Documentation Package per ordinance Section 492.6.

Attach documentation verifying implementation of recommendations from soil analysis report per ordinance Section 492.6.



LDRP Form C: Prescriptive Compliance Option

For Landscape projects that are 500 to 2,500 square feet, the following Prescriptive Compliance Option may be used. If selected, compliance with the following items is mandatory and must be documented on a landscape plan. At the time of final inspection, the permit applicant must provide the City and the owner of the property with a certificate of completion, certificate of installation, irrigation schedule and a schedule of landscape and irrigation maintenance.


Pr	oject N	Name:	PLN #:
Complete	Incomplete	Submit a Landscape Documentation Package which incl	udes the following elements:
		·	ados the lene ining elemente.
			r(s))
		· · ·	
			,
		if the applicant is not served by a private well	
		G. contact information for the project applicant and prop	erty owner
		H. applicant signature and date with statement, "I agree	to comply with the requirements of
		the prescriptive compliance option of the MWELO."	
		2. Incorporate compost at a rate of at least four cubic yards	per 1,000 square feet to a depth of
		six (6) inches into landscape area (unless contra-in	dicated by a soil test).
		3. Plant material shall comply with all of the following:	
		A. For residential areas, install climate adapted and nativ	ve plants that require occasional, little
		or no summer water (average WUCOLS plant facto	or 0.3) for seventy five percent (75%)
		of the plant area excluding edibles and areas using	recycled water; For non-residential
		areas, install climate adapted and native plants that	t require occasional, little or no
		summer water (average WUCOLS plant factor 0.3)	for 100% of the plant area excluding
		edibles and areas using recycled water;	
		B. A minimum three inch (3") layer of mulch shall be app	olied on all exposed soil surfaces of
		planting areas except in turf areas, creeping or root	ting groundcovers, or direct seeding
		applications where mulch is contraindicated.	
		4. Turf shall comply with all of the following:	
		A. Turf shall not exceed twenty five percent (25%) of the	landscape area in residential areas,
		and there shall be no turf in non-residential areas;	






Complete	Incomplete	
		B. Turf shall not be planted on sloped areas which exceed twenty five percent (25%), a slope of one (1) foot vertical elevation change for every four (4) feetof horizontal length; and
		C. Turf is prohibited in parkways less than ten feet (10') wide, unless the parkway is adjacent to a parking strip and used to enter and exit vehicles. Any turf in parkways must be irrigated by sub-surface irrigation or by other technology that creates no overspray or runoff.
		5. Irrigation systems shall comply with the following:
		A. Automatic irrigation controllers are required and must use evapotranspiration or soil moisture sensor data and utilize a rain sensor.
		B. Irrigation controllers shall be of a type which does not lose programming data in the event the primary power source is interrupted.
		C. Pressure regulators shall be installed on the irrigation system to ensure the dynamic pressure of the system is within the manufacturer's recommended pressure range.
		D. Manual shut-off valves (such as a gate valve, ball valve, or butterfly valve) shall be installed as close as possible to the point of connection of the water supply.
		E. All irrigation equipment must meet the requirements set in the ANSI standard, ASABE/ICC 802-2014. "Landscape Irrigation Sprinkler and Emitter Standard," All sprinkler heads installed in the landscape must document a distribution uniformitylow quarter of 0.65 or higher using the protocol defined in ASABE/ICC 802-2014.
		F. Areas less than ten feet (10') in width in any direction shall be irrigated with subsurface irrigation or other means that produce no runoff or overspray.
		6. For non-residential projects with landscape areas of 1,000 square feet or more, aprivate submeter(s) to measure landscape water use shall be installed.
		7. Alameda County law prohibits disposal of plant debris in county landfills. ACWMA Plant Debris Landfill Ban Ordinance 2008-01 requires landscape professionals, to separate all plant debris from garbage. http://www.recyclingrulesac.org/docs/Landfill-Ban-WMA-Ordinance2008-01.pdf



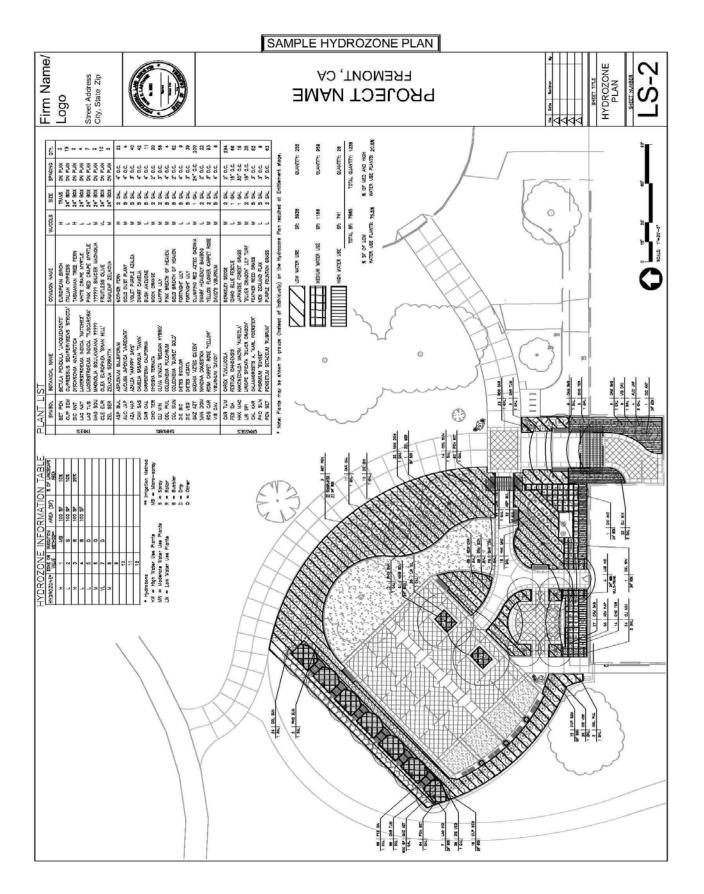



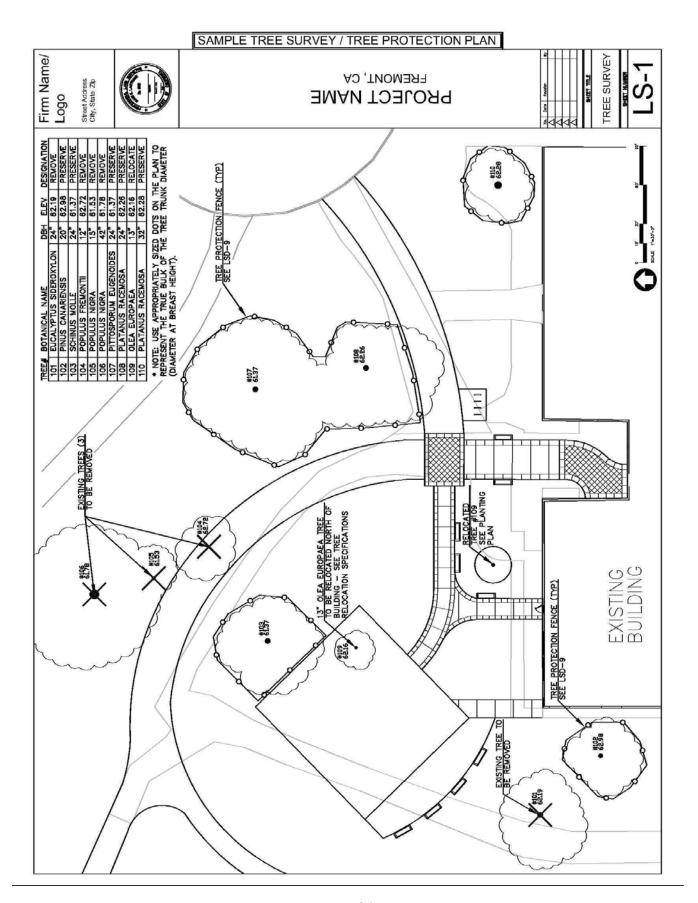



Requesting Landscape Inspection of Development <u>Projects</u>

Construction must be 100% complete before requesting inspection for Building Permit (occupancy) or Tract Acceptance. All post construction forms must be completed and submitted to the City with the inspection request.

Forms required:

- Form B, Part 1: Certificate of Completion (WELO)
- Form B, Part 2: Certificate of Installation (WELO), with following attachments:
- Form B, Part 3: Irrigation Scheduling
- Form B, Part 4: Schedule of Landscape and Irrigation Maintenance
- Form B, Part 5: Landscape Irrigation Audit Report (conducted by a Certified landscape Irrigation Auditor)
- Form B, Part 6: Soil Management Report (Include verification of implementation of recommendations from soil analysis report)

For Tract Acceptance:

*Note: Only 15% of production homes require irrigation audit.

Engineering Construction Inspection Public Works Department 39550 Liberty Street Fremont, CA 93537-5006 Ph: (510) 494-4700

Fax: (510) 494-4646

For Certificate of Occupancy:

Development Services Technician Community Development Department 39550 Liberty Street Fremont, CA 93537-5005

Ph: (510) 494-4480 Fax: (510) 494-4820

<u>Special note for Temporary Occupancy Requests:</u> Temporary Occupancies are handled on a case-by-case basis. At a minimum, landscape must be substantially complete with only minor items remaining. In cases where Temporary Occupancies are considered by the City, the Certificate of Completion (Form B, Part 1) and the Certificate of Installation (Form B, Part 2) may be temporarily substituted for a detailed punch-list prepared by the Project Landscape Architect. The punch list shall document all minor items remaining that must be completed before Final Occupancy. Certificate of Completion (Form B, Part 1) and the Certificate of Installation (Form B, Part 2) and follow-up City inspection is still required before Final Occupancy.

Miscellaneous Landscape Inspection Requests:

City Landscape Architect Community Services Department 39550 Liberty Street Fremont, CA 94537-5006 Ph: (510) 494-4700

Fax: (510) 494-4721



Arborist Analysis Report Standards

Note: Arborist analysis is only required if requested by the city and is not a standard submittal item on development projects or as part of a Tree Removal Application. The applicant may choose to provide an arborist analysis at his or her discretion, in advance of a potential request by the city.

An arborist analysis report is required to make a more detailed assessment of an individual tree's suitability for preservation or assessment of a proposed design near an existing tree. The report shall be prepared by an Arborist, certified by the ISA (International Society of Arboriculture) and approved by the City of Fremont. The City will require a deposit (estimated amount) from the applicant in order to cover the cost of the arborist report. If the applicant uses their own approved Arborist, the deposit may be required for a peer review of the Arborist report. Any unused amount of the deposit will be returned to the applicant.

The arborist report will include, at a minimum, the following factors in the evaluation of suitability for preservation:

*Tree health

Healthy, vigorous trees are better able to tolerate impacts such as root injury, demolition of existing structures, changes in soil grade and moisture, and soil compaction, than are non-vigorous trees.

*Structural Integrity

Trees with significant amounts of wood decay and other structural defects that cannot be corrected are likely to fail. Such trees will not be preserved in areas where damage to people or property is likely to occur.

*Species response

There is a wide variation in the response of individual species to construction impacts and changes in the environment.

*Tree age and longevity

Old trees, while having significant emotional and aesthetic appeal, sometimes have limited physiological capacity to adjust to an altered environment. Young trees are better able to generate new tissue and respond to change. Older trees may require modifications to the development proposal, to achieve preservation.

*Other evaluation as identified by the City

Each project has unique features that may impact trees. The analysis will explore innovative alternatives in design that promote preservation of quality trees. The City may choose to require tree appraisals on complex projects where significant development may occur near trees to be preserved. Tree appraisals will provide a basis of penalties for destruction of trees during construction and may be used to assess mitigation on projects with significant tree removal.

Give each tree a rating for suitability for preservation based upon its age, health, structural condition, and tree's ability to exist safely within the development environment.





TREE PERMIT & **APPLICATION**

INSTRUCTIONS

- Complete all fields of this form as incomplete applications will delay request.
 A fee is not required.

Tree P	ermit #:
	=
/Ear Office	Use Only)

See additional instructions/rec Submit completed application For inquiries, please call the tre	to treepermits@fren			(For Office Use Only)
APPLICATION DATE:/_		Permit not vali	d without City approv	ed signature and date stamp
PERMIT TYPE:				YAR DATE OF THE STATE OF
TREET TREE: Select one of t Note: Leave this section blank	THE RESERVE THE PARTY OF THE PA	☐ Planting Permit ☐ Removal Permit	☐ Pruning Pe ☐ Root Pruni	
RIVATE PROTECTED TREE: Note: Leave this section blank		☐ Removal Permit		1
WNER INFORMATION: Required for all applicants			CONTRACTOR IN Required for street tre	
AME: TREET ADDRESS:				
IPCODE: ELEPHONE #: MAIL ADDRESS:				
grant the City or City's agent p any development planned for			17 (6)	□ No): □ Yes □ No
REE INFORMATION: PECIES:				QUANTITY:
REFERRED REPLACEMENT Replacement tree required.	TREE(S):		* .	
EASON FOR REMOVAL: Please attach picture with appl	ication.			
Additional Requirements: All so rom the date of approval (see International Society of Arborica	e expiration date be	elow). Install trees per (o-foot depth minimum. T City Standard Detail LS	his permit expires in 6 month: D-1. All pruning must be pe
To appeal a permit denial before the City Council, contact the	Species			Date Stamp:
City Clerk's office within ten days from the date of this notice.	Size:	w Trees: be complete within 30 o		
Oan (010) 204-4000	but before exp	iration of permit. Call (i	510) 494-4730 for	Permit expires 6 months from stamped date.
ontact:			/For C	Office Use Only)
ee Permits 550 Liberty St., P.O. Box 5006 ° ee Permit Line: (510) 494-4730			Mitigation Complete:	Inspected By:
				Rev. 05/05/201



A PERMIT IS REQUIRED PER FMC 4-5100 UNDER THE FOLLOWING CONDITIONS:

YOU DO ne	eed a tree removal permit if the tree meets one or more of the following size conditions:
	Any size DBH (any species**) if the tree was required or preserved through a previous development approval, 6" DBH* or larger (any species**) if on underdeveloped or vacant land, 10" DBH* or larger if native to Fremont***, or
	18" DBH* or larger (any species**).
C. C	he tree is located on one or more of the following types of properties:
	Any City approved development on any size property were the tree was required or the tree was preserved,
	The front yard of any Single Family Home lot 10,000 square feet or less (a side yard facing a street on a corner lot is regulated as a front yard.),
32772	Any Single Family Home lot larger than 10,000 square feet, or
	Any non-Single Family Home lot in Fremont.
YOU DO N	<u>OT</u> need a permit if the tree is:
	ed in the rear or side yard of any Single Family Home lot 10,000 square feet or less (unless specifically required revious development approval or is listed the City Landmark Tree List.)
Notes and Defin	itions:
	BH – Diameter at Breast Height (Trunk diameter measured four and one half feet from ground level).
Fo	r multi-trunk trees, DBH is the sum total of all trunks added together (measured 4 1/2 feet from ground level).
	r low branching trees with substantial branches below four and one half feet from ground level, DBH is assured below the lowest branch attachment.
	ceptions include commercial-type fruit or nut bearing trees, which DO NOT require a permit (except Walnuts and ives are protected and therefore require permits),
***Tre Sye ada	sees Native to Fremont are regulated starting at 10 " DBH, and includes Oak, Redwood, Buckeye, Madrone, camore, Big-Leaf Maple, Redbud, and Bay. Additionally, a list of non-native trees that have exceptional aptability to Fremont and are treated as native trees, include Fremont Cottonwood, California Pepper, European
Oli	ive, Black Walnut, and Deodar Cedar. For all other tree species refer to table above for permit requirements.

CRITERIA FOR GRANTING PERMITS:

The City promotes options for preservation of mature healthy trees whenever possible. Per FMC 4-5106, tree removal permit will be considered for approval if the tree: 1) is hazardous to person or property and cannot be corrected to be safe, 2) has a short life expectancy, 3) is a host to disease that endangers other trees, 4) is part of a group that is overcrowded, 5) makes reasonable development of the property impossible, 6) makes full enjoyment of an existing structure or utility (gas, water, etc.) impossible., or 7) has been damaged to the extent that it cannot be feasibly restored.

If a permit is granted, a 24" box size replacement tree will be required (15 gallon size tree is required for homeowners). The tree species should be of similar type and size as the tree removed. A subsequent arborist report or tree survey paid by the applicant may be required to determine if tree meets criteria for removal, such as described above.

INSTRUCTIONS FOR COMPLETING APPLICATION:

- If you have a development application pending or contemplated with the City, do not use this application.
 Application for tree removals will be considered together with your development.
- Fill out the top portion of the application on the opposite side of this sheet. A fee is not required. Incomplete applications will delay approval process or application may be returned.
- 3. Mail (front page only) or bring in person to the City Landscape Architect at:

City of Fremont, Engineering Division

39550 Liberty Street

Fremont, CA 94537-5006,

(or) E-mail pdf of complete application to rravenstad@ci.fremont.ca.us

- Include your phone number so city staff can call with questions.
- Expect two to four weeks for a fully processed application unless the City requires additional information.
 Applications must be made at least 15 days before proposed date for tree removal.
- Call (510) 494-4700 for final inspection after replacement tree(s) is planted.



Resources, Publications and Documents

- 1. Bay-Friendly Landscape Guidelines(Book), Alameda County Waste Management (akawww.stopwaste.org)
- 2. Water Use Classification of Landscape Species (WUCOLS), University of California cooperative Extension. (http://ucanr.edu/sites/WUCOLS)
- 3. City of Fremont Stormwater Treatment Requirements (https://city.fremont.gov/stormwaterpermit)
- 4. C.3 Stormwater Technical Guidance Manual, Alameda Countywide Clean Water Program (https://www.cleanwaterprogram.org/businesses/development.html)
- 5. State Water Resources Control Board. (http://www.waterboards.ca.gov)
- 6. Sunset Western Garden Book, Lane Publishing.
- 7. Plants and Landscapes for Summer Dry Climates (Book), East Bay Municipal Utility District
- 8. Trees and Development: A Technical Guide to Preservation of Trees During Land Development (Book), International Society of Arboriculture (Matheny, Clark)
- 9. California Irrigation Management Information Systems, State of California, Department of Water Resources, (www.cimis.water.ca.gov)
- 10. International Society of Arboriculture. (<u>www.isa-arbor.com</u>)
- 11. American Society of Consulting Arborists. (<u>www.asca-consultants.org</u>)
- 12. *Trees are Good.* Professional and consumer information on trees from International Society of Arboriculture (www.treesaregood.org)
- 13. Calculate the ecological and financial benefit of your tree. I-Tree is based on USDA Forest Service "Statum" tree assessment tool. (http://www.treebenefits.com/calculator/index.cfm)




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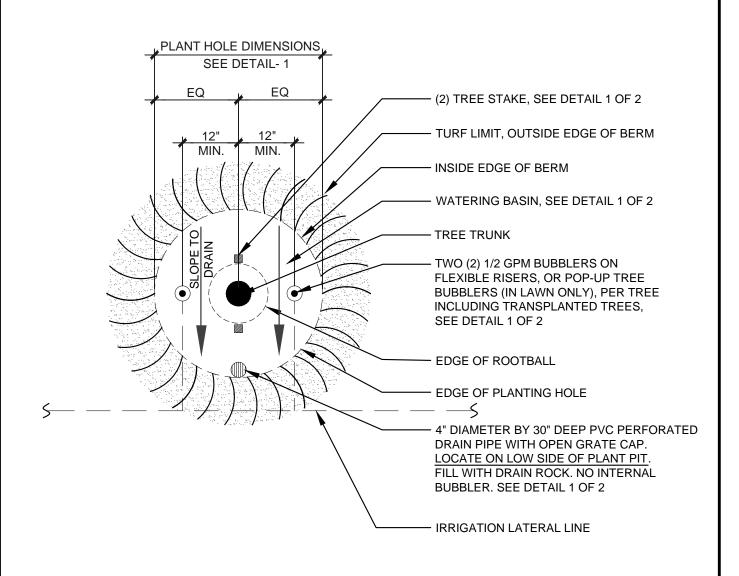


LANDSCAPE STANDARD DETAILS (LSD) FOR CITY PROJECTS AND RIGHT-OF-WAY


Table of Contents

DETAIL NO.	<u>TITLE</u>
LSD-1	TREE PLANTING AND STAKING (2 pages)
LSD-2	TREE PLANTING WITH TREE GRATE (2 pages)
LSD-3	SHRUB AND GROUNDCOVER PLANTING
LSD-4	SHRUB AND GROUNDCOVER LAYOUT
LSD-5	STREET TREE CLEARANCES
LSD-6	TREE CLEARANCES
LSD-7	MEDIAN COBBLE PAVING
LSD-8	MAINTENANCE BAND
LSD-9	TREE PROTECTION FENCING
LSD-10	TEMPORARY TRUNK WRAP
LSD-11	Not used
LSD-12	TREE AND SHRUB PLANTING ON SLOPE
LSD-13	TREE PLANTING GUIDE (LIST)
LSD-14	IRRIGATION MATERIALS
LSD-15	IRRIGATION CONTROLLER CABINET w/ CALSENSE CONTROLLER
LSD-16	BACKFLOW PREVENTOR UNIT
LSD-17	BACKFLOW PREVENTOR UNIT CAGE
LSD-18	IRRIGATION TRENCH
LSD-19	QUICK COUPLING VALVE IN BOX
LSD-20	IRRIGATION WIRE SPLICE (2 pages)
LSD-21	IRRIGATION ROTOR OR POP-UP
LSD-22	IRRIGATION GATE VALVE
LSD-23	REMOTE CONTROL VALVE W/ GATE VALVE
LSD-24	MASTER VALVE AND FLOW SENSOR
LSD-25	PRESSURE REDUCTION VALVE
LSD-26	IRRIGATION WYE STRAINER
LSD-27	LANDMARK TREE PLAQUE
LSD-28	LANDMARK TREE RAILING
LSD-29	STORMWATER TREEWELL (2 pages)
LSD-30	STORMWATER PLANTER (4 pages)
LSD-31	STORMWATER TRASH CAPTURE INLET (3 pages)



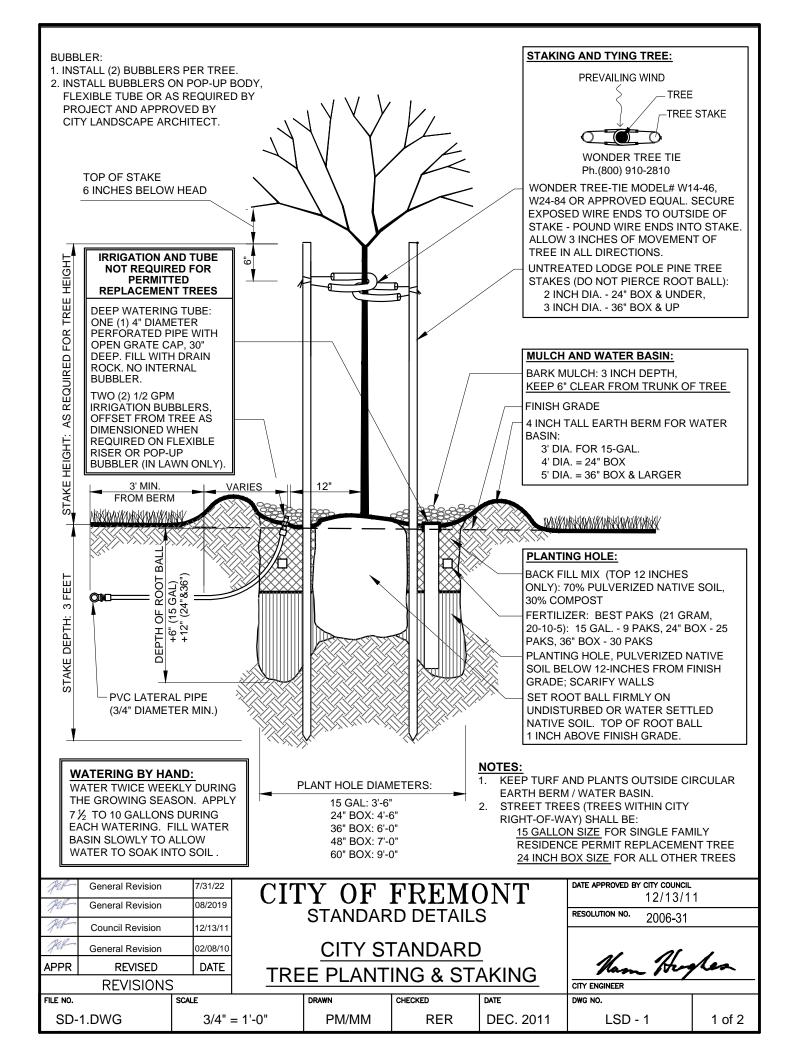



Jul-	General Revision	n 07/31/22	CIT	'Y OF	FREMO	NT	DATE APPROVED BY CITY COUNCIL		
Jak	General Revision	n 08/2019	011				RESOLUTION NO. 2006-31		
Pak	Council Revision	12/13/11		SIANDAN					
Jak	General Revision	n 02/08/10		CITY ST	TANDARD		-1 01		
APPR	REVISED	DATE	TDE	TREE PLANTING (PLAN VIEW)			Ham Hay	des	
REVISIONS			1111	_ F LANTII	NG (FLAIN	I VILVV)	CITY ENGINEER		
FILE NO.		SCALE		DRAWN	CHECKED	DATE	DWG NO.		
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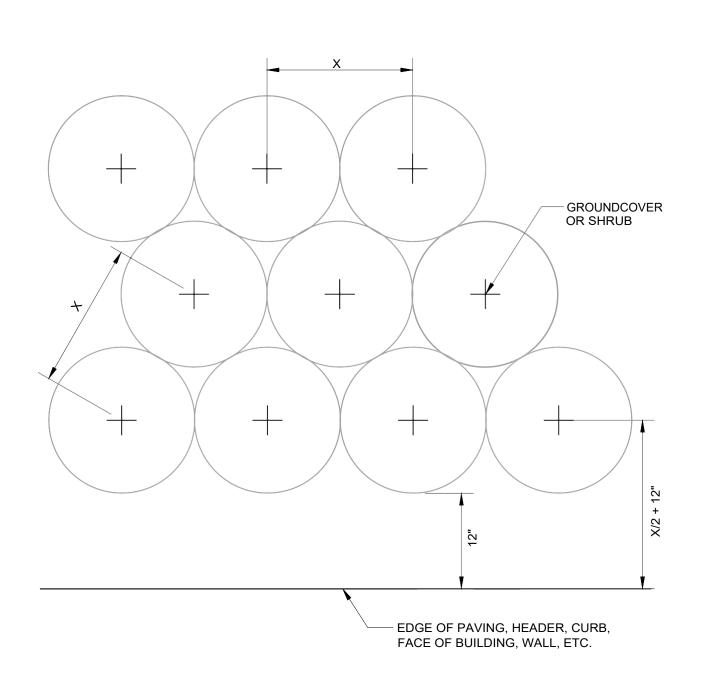
- 2. WHERE REQUIRED, TREE GRATE TO BE FIVE (5) FEET X TEN (10) FEET. MAKE AND MODEL SHALL BE NEENAH R-8823 (8823-100 METROPOLITAN COLLECTION), OR APPROVED EQUAL.
- 3. WHERE REQUIRED, TREE GRATE TO BE FIVE (5) FEET X FIFTEEN (15) FEET MAKE AND MODEL SHALL BE NEENAH R-8823 SPECIAL (8823T05 METROPOLITAN COLLECTION), OR APPROVED EQUAL.
- 4. TREE GRATE TO BE UNFINISHED.
- 5. REFER TO DETAIL LSD-1 FOR MORE INFORMATION, 1 OF 1 AND 2 OF 2.
- 6. STREET TREES (TREES WITHIN RIGHT-OF-WAY) SHALL BE 24 INCH BOX SIZE, MINIMUM.
- 7. ROOT BARRIERS SHALL NOT BE INSTALLED UNLESS DIRECTED BY CITY LANDSCAPE ARCHITECT.

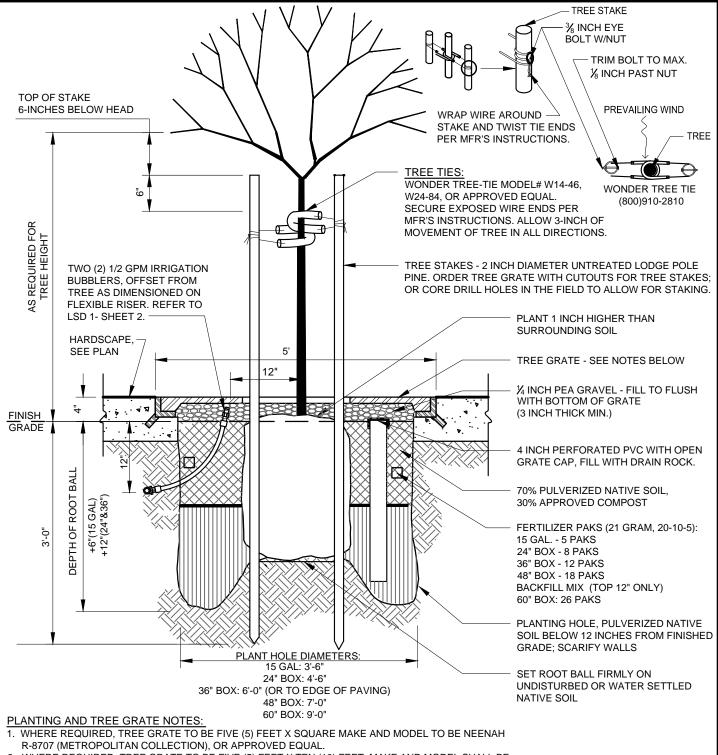				Y OF	T T T T T T T T T T T T T T T T T T T		12/13 RESOLUTION NO. 2006 3	/11
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APPR	REVISED	DATE		MITH TD	EE GRAT	<u> </u>	Ham He	gles
	REVISIONS			VVIII IK	LL GRAI	<u>L</u>	CITY ENGINEER	
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			CIT	Y OF			DATE APPROVED BY CITY COUNTY 12/13	
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RIK				CITY S	TANDARD)		
Lor	General Revision	08/2019	SHB	UB AND	CROLINID	Ō\/FR	1 11	
APPR	REVISED	DATE	5111			COVER	Ham He	gles
	REVISIONS	;		PLA	NTING		CITY ENGINEER	
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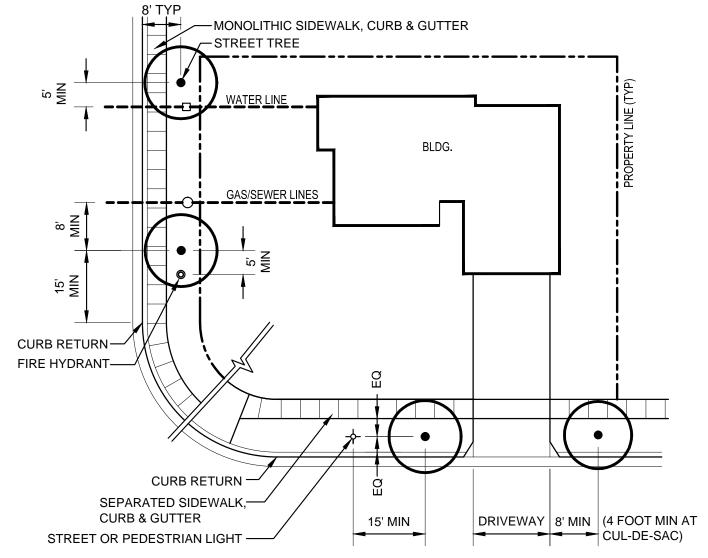


- 1. 'X' IS GROUNDCOVER AND SHRUB SPACING PER THE LANDSCAPE PLAN, PLANT LIST, AND LEGEND.
- 2. KEEP MULCH CLEAR OF PLANT BASE (SEE LSD-3 & LSD-12)

			CIT	Y OF	FREMO	ONT	DATE APPROVED BY CITY COUNCIL 12/13/1	
				STANDAR	D DETAILS	S	RESOLUTION NO. 2006-3	1
	Council Revision	12/13/11		CITY ST	ANDARD	-	2000 0	'
MA	General Revision	n 03/17/11	SHR	UB AND C	ROUNDO	OVER	11 11	/
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	REVISIONS						CITY ENGINEER	
FILE NO.		SCALE		DRAWN	CHECKED	DATE	DWG NO.	
LS	LSD-4.DWG 1" =		: 1'-0"	PM/MM	RER	DEC. 2011	LSD-4	1 of 1

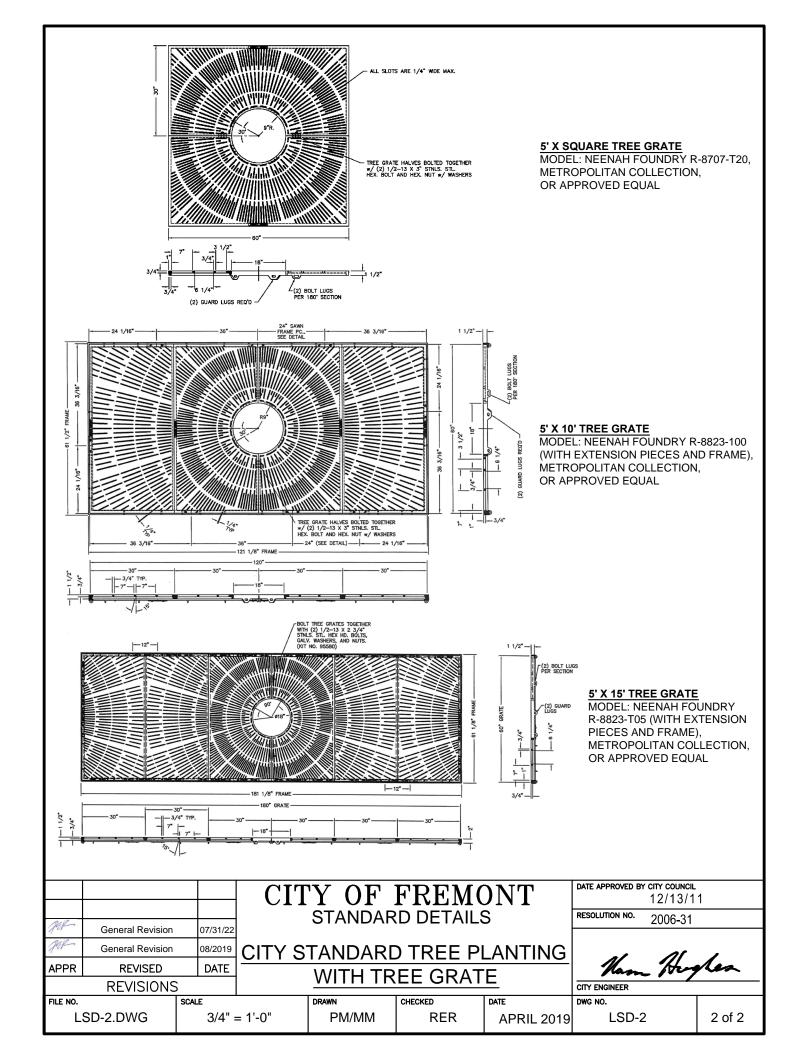MINIMUM STREET TREE CLEARANCES

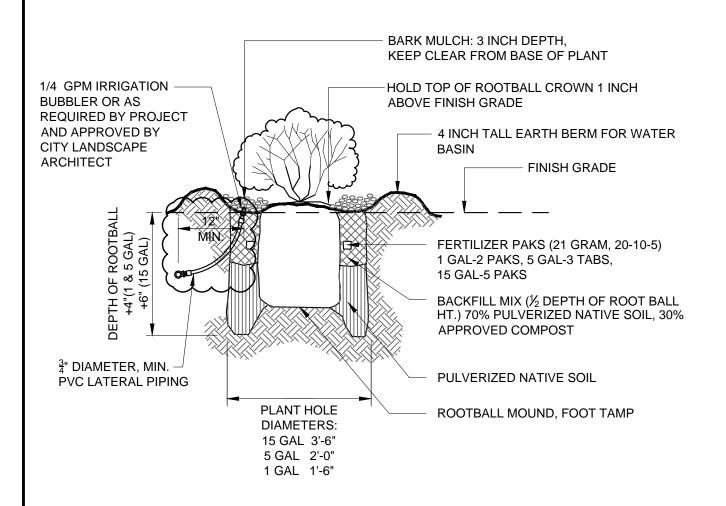- 1. STREET TREES SHALL BE LOCATED 8 FEET (MIN) FROM SANITARY SEWER, GAS, AND STORMWATER LINES.
- 2. STREET TREES SHALL BE LOCATED 5 FEET (MIN) FROM WATER, TELEPHONE AND ELECTRICAL LINES AND UTILITY BOXES.
- 3. STREET TREES SHALL BE LOCATED 5 FEET (MIN) FROM FIRE HYDRANTS.
- 4. STREET TREES SHALL BE LOCATED 15 FEET (MIN) FROM STREET LIGHTS.
- 5. STREET TREES SHALL BE LOCATED 8 FEET (MIN) FROM DRIVEWAYS AND 4 FEET (MIN) AT CUL-DE-SAC.
- 6. STREET TREES SHALL BE GENERALLY 35 FEET ON CENTER.
- 7. MINIMUM ONE TREE PER LOT REQUIRED, AND TWO PER CORNER LOT.
- 8. IF LOT WIDTH EXCEEDS 60 FEET AT THE STREET, ONE TREE IS REQUIRED EVERY 35 FEET OF STREET, EXCLUDING LENGTH OF CURB RETURN.
- 9. COORDINATE TRAFFIC SIGNS AND SIGNAL LOCATIONS SO THAT THESE ARE NOT OBSTRUCTED BY STREET TREE LOCATIONS.
- 10. STREET TREES SHALL BE PLACED A MINIMUM OF 50 FEET AWAY FROM NEAREST TRAFFIC SIGNAL POLE IN THE DIRECTION OF TRAVEL.



NOTE:


CURRENT STANDARD DETAIL AT CITY ENGINEERING DIVISION SHALL PREVAIL

			CIT	'Y OF			DATE APPROVED BY CITY COUNC 12/13/	
Pak	General Revision	07/31/22		STANDARD DETAILS			RESOLUTION NO. 2006-31	
Pak	General Revision	08/2019		CITY ST	ANDARD	<u> </u>	-1 05	,
APPR	REVISED	DATE	STRE	EET TREE	CLEARA	ANCES Nam Huglen		
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LS	LSD-05.DWG 1" =		20'-0"	PM/MM	RER	OCT. 2005	LSD-5	1 of 1

MINIMUM TREE CLEARANCES FROM BUILDINGS

BRANCHES FROM MATURE TREES MAY NOT OVERHANG BUILDINGS AND ROOFS. ADEQUATE SPACE TO PLANT TREES ADJACENT TO BUILDINGS OR OTHER BUILT FEATURES MUST BE PROVIDED IN THE FOLLOWING MINIMUM WAYS:


- 1. SMALL TREES (TO 15 FEET TALL AT MATURITY) NO CLOSER THAN 6 FEET FROM BUILDING OR 2 FEET* FROM PAVING, CURBS, OR WALLS WITH A MINIMUM PLANTING AREA 5 FEET WIDE.
- 2. MEDIUM TREES (TO 35 FEET TALL AT MATURITY) NO CLOSER THAN 10 FEET FROM BUILDING OR 3 FEET* FROM PAVING, CURBS, OR WALLS WITH A MINIMUM PLANTING AREA 6 FEET WIDE.
- 3. LARGE TREES (ABOVE 35 FEET TALL AT MATURITY) NO CLOSER THAN 15 FEET FROM BUILDING ORE 3 FEET* FROM PAVING, CURBS, OR WALLS WITH A MINIMUM PLANTING AREA 6 FEET WIDE, PREFERABLY
- 4. WHEN ROOF EAVES OR BUILDING PROJECTIONS EXTEND BEYOND FACE OF BUILDING, CLEARANCE SHALL BE MEASURED FROM EDGE OF PROJECTION TO CENTERLINE OF TREE.
- 5. UPPER STORY OVERHANGS AND BUILDING FEATURES MAY NOT EXTEND WITHIN MINIMUM CLEARANCE EXCEPT FOR MINOR ROOF EAVES.
- * REFER TO CITY STANDARD DETAIL LSD-05 FOR REQUIRED SPACING FROM UTILITIES.

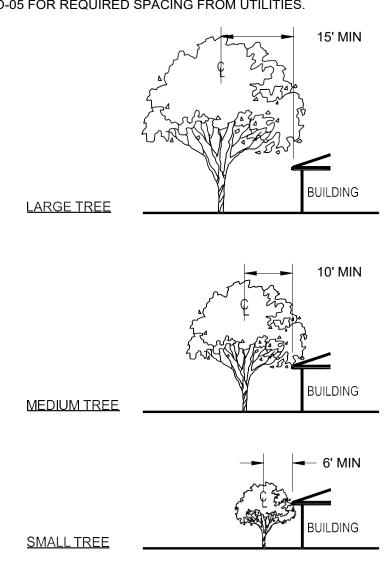


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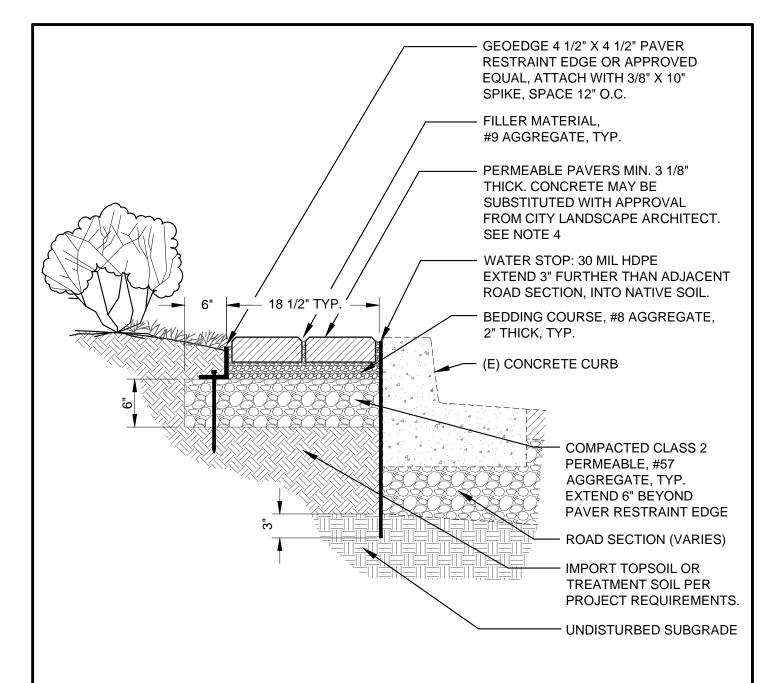
1 of 1



- 1. CURRENT STANDARD DETAIL AT CITY ENGINEERING DIVISION SHALL PREVAIL.
- 2. CROWN TO BE ROUNDED WITH NO SHARP GRADE BREAKS.
- 3. MINIMIZE VISIBLE EXPOSED GROUT AT COBBLE JOINTS.
- 4. SURFACE OF COBBLE FIELD TO BE SMOOTH AND FLAT TO GRADE WITHOUT VARIATION IN HEIGHT OF INDIVIDUAL COBBLES.
- 5. COBBLES WITH BREAKS OR FRACTURES ARE NOT ALLOWED.
- 6. ROCK SHALL BE 'SATURATED SURFACE MOIST' (SSM) PRIOR TO PLACEMENT.
- 7. CONCRETE BED SHALL HAVE A CEMENT RATIO PER CUBIC YARD OF CONCRETE OF NOT LESS THAN 564 POUNDS; SLUMP MAX. OF 3"; AGGREGATE SIZE ½" MAXIMUM.
- 8. INTEGRAL COLOR ADMIXTURE: COLOR 641-YOSEMITE BROWN, BY DAVIS COLOR, C-21 CHROMIX G & L ADMIXTURE, BY SCOFIELD, OR APPROVED EQUAL. ADMIXTURE CAN BE GRANULAR (G), LIQUID (L), OR POWDERED (P).

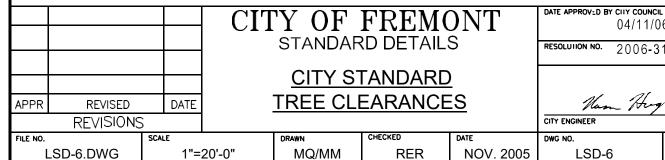


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- 1. ON MEDIANS LESS THAN 14 FEET WIDE, REPLACE MAINTENANCE BAND WITH 18 INCH MINIMUM WIDTH PLANTING OF WALKABLE GROUNDCOVER.
- 2. IF CONCRETE, INSTALL DEEP JOINTS TO MATCH CURB & GUTTER DEEP JOINTS. SEE ENGINEERING STANDARD DETAIL 8 FOR DEFINITION OF DEEP JOINT.
- 3. FOR PAVERS WITHIN THE DRIPLINE OF AN EXISTING TREE, HAND EXCAVATE ALL AREAS. 6" THICK, CLASS 2 PERMEABLE LAYER MAY BE REDUCED OR ELIMINATED, IF NECESSARY. SEE LSD-9 FOR TREE PRESERVATION NOTES.
- 4. PAVERS TO BE: 6 X 9 X 3 1/8 CALSTONE PERMEABLE PAVING UNITS, COLOR: RUSTIC YELLOW STONE. SUBSTITUTIONS TO BE APPROVED BY THE CITY LANDSCAPE ARCHITECT.

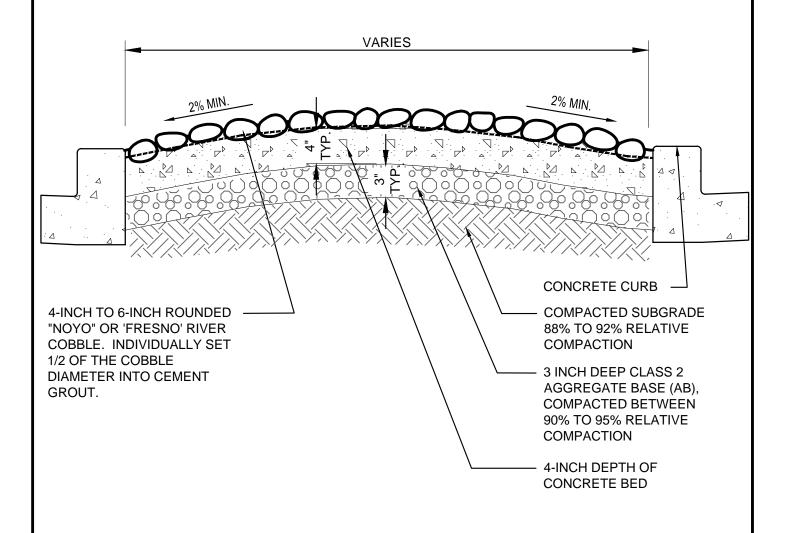
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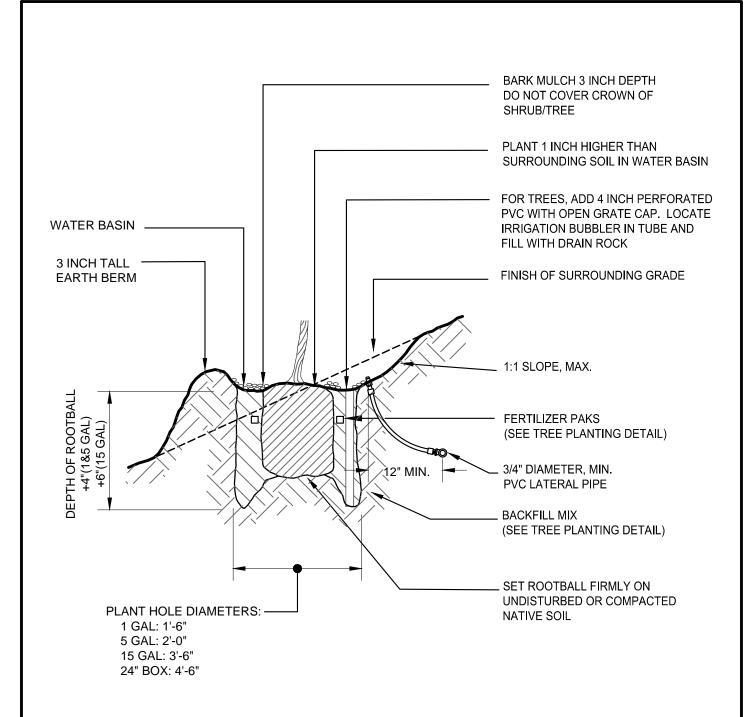


TREE PROTECTION NOTES

- 1. CURRENT STANDARD DETAIL AT CITY ENGINEERING DIVISION SHALL PREVAIL.
- 2. TREE PROTECTION MEASURES MUST BE IN PLACE BEFORE CONSTRUCTION, DEMOLITION AND/OR GRADING ACTIVITIES COMMENCE. CITY OF FREMONT WILL STOP CONSTRUCTION IF TREE PROTECTION MEASURES ARE NOT IN PLACE AND MAINTAINED THROUGHOUT THE CONSTRUCTION PERIOD.
- 3. TREES CALLED OUT FOR PRESERVATION SHALL BE FENCED AT THE DRIPLINE. FENCING MAY OCCUR AT THE COMBINED DRIPLINES OF GROVES OF TREES. PLACE 4-6 INCH BARK MULCH BENEATH DRIPLINES OF TREES TO BE PRESERVED. KEEP BARK 2-3 FEET FROM TREE TRUNK.
- 4. FENCING SHALL BE 6 FEET TALL CHAIN LINK FENCING WITH STEEL POSTS EMBEDDED IN THE GROUND.
- 5. NO GRADING SHALL OCCUR WITHIN THE DRIPLINES/FENCED AREA OF EXISTING TREES.
- 6. NO CONSTRUCTION MATERIALS OR CONSTRUCTION VEHICLES MAY BE STORED WITHIN THE DRIPLINES/FENCED AREA OF EXISTING TREES.
- 7. CONSTRUCTION VEHICLES OR MACHINERY MAY NOT PASS BETWEEN TWO OR MORE EXISTING TREES IDENTIFIED FOR PRESERVATION IF THEIR CANOPIES ARE WITHIN 10 FEET OF TOUCHING. ADDITIONAL FENCING MAY BE REQUIRED BY THE CITY AS NEEDED.
- 8. THE CONTRACTOR IS REQUIRED TO HAVE AN ARBORIST CERTIFIED BY THE INTERNATIONAL SOCIETY OF ARBORICULTURE (ISA), APPROVED BY THE CITY, ON SITE IF SITE CONSTRUCTION EFFORTS REQUIRE REMOVAL OF EXISTING ROOTS OR BRANCH PRUNING. ROOTS APPROVED FOR CUTTING MUST BE CUT CLEANLY WITH A SAW. RIPPING OR SHREADING ROOTS SUBJECT TO FINE/PENALTY.
- 9. UNAUTHORIZED TREE REMOVAL IS SUBJECT TO REPLACEMENT EQUAL TO THE APPRAISED VALUE OF THE TREE LOST PER FMC 4-5108.
- 10. THE CONTRACTOR IS REQUIRED TO WATER, FERTILIZE AND ATTEND TO OTHER MAINTENANCE NEEDS OF EXISTING TREES TO MAINTAIN HEALTHY GROWTH THROUGHOUT THE CONSTRUCTION PERIOD. AN EARTH BERM MEASURING MINIMUM 6 FEET IN DIAMETER, AND 6 INCHES IN HEIGHT SHALL BE CONSTRUCTED AT THE BASE OF EACH TREE TO FUNCTION AS A TEMPORARY WATERING BASIN DURING THE CONSTRUCTION PERIOD. TREES SHALL BE WATERED ACCORDING TO WEATHER AND TREE SPECIES REQUIREMENTS.
- 11. IF TREES ARE BEING RELOCATED: RELOCATION OF EXISTING TREES SHALL OCCUR UNDER THE OBSERVATION AND DIRECTION OF A CERTIFIED ARBORIST APPROVED BY THE CITY OF FREMONT.
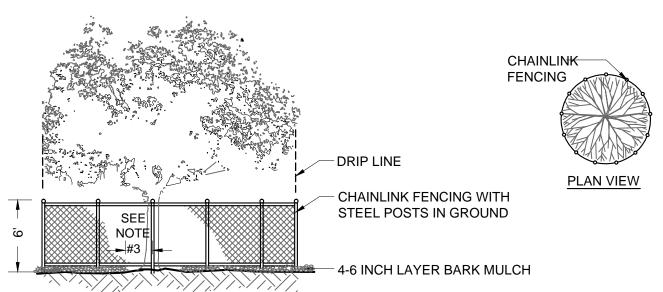
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LS	LSD-9.DWG 1/8"		= 1'-0"	PM/MM	RER	DEC. 2011	LSD-9	1 of 1



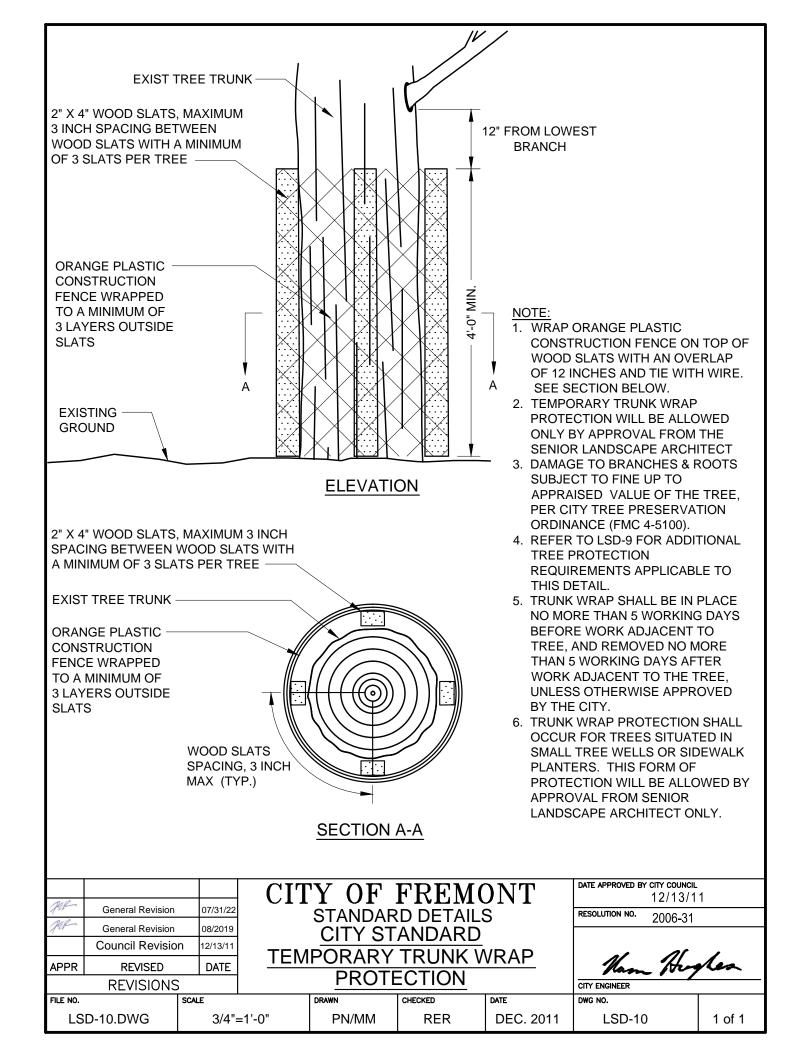

- 1. KEEP TURF AND PLANTS OUTSIDE THE EARTH BERM/WATER BASIN.
- 2. SEE TREE PLANTING DETAIL FOR STAKING AND BUBBLER INFORMATION, LSD-01, SHEET 1&2, AND LSD-03.
- 3. INSTALL BUBBLERS ON UPHILL SIDE OF PLANTING PIT.


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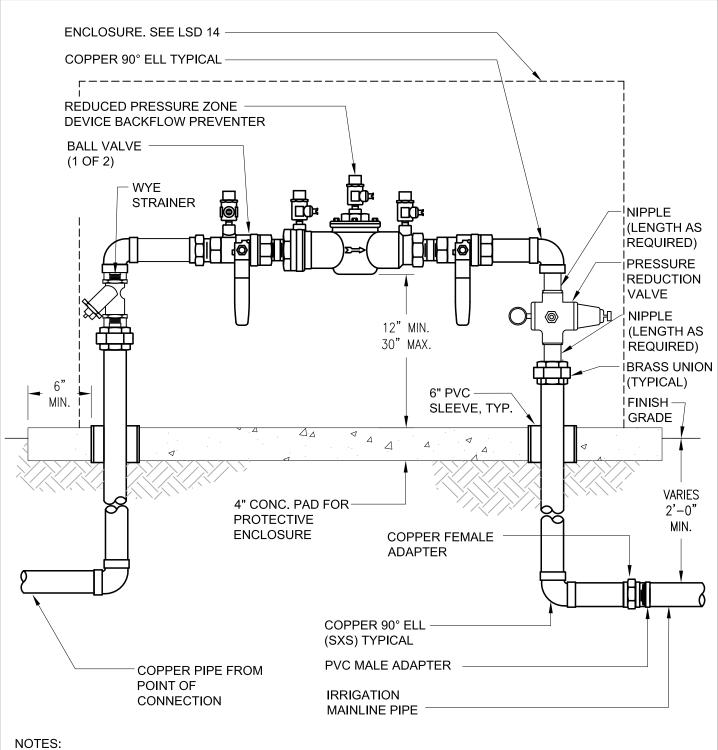
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TREE CHOICES ARE NOT LIMITED TO THIS LIST. THIS LIST IS ONLY A GUIDE.

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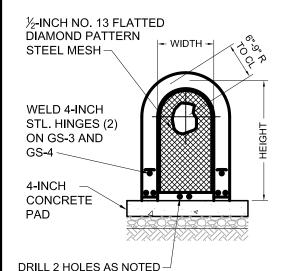
STANDARD	CITY O	F FREMON	T IRRIGA	TION STANI	DARD M	ATERIALS	LANDSCAF STANDAR
SYMBOL	DESCRIPTION	MANUFACTURE	R MODEL#	(if applicable)		COMMENTS	DETAIL
	Tree Bubblers	Toro	PC-FB-50			Trees with flex pipe	LSD-01 8
	Tree Dubblets	1010	570S/PC-F	B-50		Trees in lawn with pop-up	LSD-02
	Flexible Hose	Salcodrip	SLV-PVC-I	PS-050-100		1/2" IPS LSD-01	, LSD-02, LSD-
	Shrub Bubblers	Toro	PC-FB-25			Shrubs	LSD-03
⟨c⟩	Irrigation Controller	Calsense 3000		v/ single controller, 1 S3 - XX - S1/CS3 -LF XX		Include all applicable software as required by the city, and dome antenna. Provide one remote contper controller.	
(<u>c</u>)	with Enclosure	Gaiserise 3000	CS3 - XX -	vall mount, 1 antenna WM1/CS3-LR/L Stul vith master and slave	bby/FMXX	Master: CS3-XX-S1/CS3-LR/LR-Stubby/ CS3-MSSE-KIT/CS3-FL/FMXX Slave:	LSD-15
			C33-33E \	vitii iiiastei aliu siave		CS3-XX-S/CS3-MSSE-KIT/CS3-F	L
	Irrigation Controller Enclosure	Calsense Enclos Strong Box	PED - 245	5, 12" riser 24" wide enclosure		Heavy-Duty Stainless Steel	LSD-15
X	Reduced Pressure-Principle Backflow Preventer with cage and concrete pad	Febco	825-Y				LSD-16
Y	'Y' Strainer	Febco	650A 1/2"-	2"			LSD-16
	Pressure Reducing Valve	Zurn/Wilkins	500 XL			With integral bypass check valve & in-line pressure gauge	LSD-16
	Ball Valve	KBI WATTS	WLT Serie LFFBV-4 2	s, Plastic Piece. Full Port. Bra	ss. Threaded		LSD-16 8 LSD-23
	Backflow Assembly Cage	Guardshack	GS Series	, . a ori, bla	,	Powdercoat Black	LSD-17
	Irrigation Trench - Mainline			C for 2" & less PVC for 2-1/2" and I	arger	24" below finish grade, min.	LSD-18
	Irrigation Trench - Lateral line			C for line 1" and smaps		12" min. to 18" max. below finish grade	LSD-18
===	Sleeves		Class 315	PVC		See LSD-18 for depth and size	LSD-18
•	Quick-Coupling Valve (in box)	Hunter	HQ-44LRC HK-44A (K			Winged body w/ 1" key, locking cover, and key with swivel	LSD-19
	Quick-Coupling Valve Box	Carson Old Castle	910 Lockal	05		Round box with lid	LSD-19
	Communication Cable	Pentek Paige	Superflexo P7171D-R			18 AWG	LSD-20
	Wire Splice	Scotchcast conn		ck 3570G-N			
	wile Oplice	<u> </u>	ice Kit DBR-Y (Kit			Install per detail LSD-20	LSD-20
	Turf Sprinklers	Toro Hunter	Super 700 I-40 OR I-2	C Series 20-06-SS, 360 d, AD	J	Adjustable arc, stainless steel rise check valve, 8 standard, 4 low and nozzles	
	Turf Sprinklers	Toro	640 Series			Large Turf Areas	LSD-21
	Turf Sprinklers	Toro	570Z-PRX	COM-6P/12P-O-T P	recision Series	Small Turf Areas; pressure regulation and x-flow	LSD-21
	Shrub/Groundcover	Toro	570Z-PRX	COM-6P/12P-O-T P	recision Series	Shrub/Groundcover Areas; pressure regulation and x-flow	LSD-21
H	Gate Valve (in box)	Nibco	T-113-K T-113			Class 125 bronze, screw-in bonne threaded, non-stem rising, solid w Class 150 Bronze, bolted bonnet, stem rising, split wedge threaded	edge. non- LSD-22
	Gate Valve Box	Carson Old Castle	910 Lockal Concrete G	05		10" Round box with lid	LSD-22
•	Remote Control Valve (in box)	Pentek Griswold	Superflexo 2000 Serie		/alve	NC = Normally Closed	LSD-23
	Remote Control Valve Box	Carson	L Series 13	24-12 Lockable		13" x 24" 13" x 18" box with lid	LSD-23
	ID Tags	Pentek Christy Standard Tag-2 S	Superflexo 2.25" x 2.6 Sided ID.STD.X2			14" x 19" box with lid	LSD-23
FS	Flow Sensor	Calsense		5B, 1.5B, FM2, FM2	B, FM3, FM3BX	(LSD-24
MV	Master Valve	Griswold	2160 Serie			NO = Normally Open	LSD-24
	s shown are city standard for the	nose items.					
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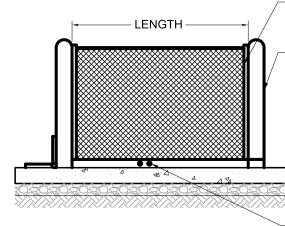




- INSTALL BACKFLOW PREVENTER AS REQUIRED BY LOCAL CODES AND HEALTH DEPARTMENT. VERIFY LOCAL REQUIREMENTS PRIOR TO INSTALLATION.
- INSTALL FREEZE PROTECTION JACKET AND ENCLOSURE. SEE CITY STANDARD DETAIL LSD-17 FOR CAGE DETAIL.
- REFER TO CITY STANDARD DETAIL LSD-14 FOR ALL MATERIALS

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WELD MESH TO PIPE, ANGLE IRON AND STEEL STRAP

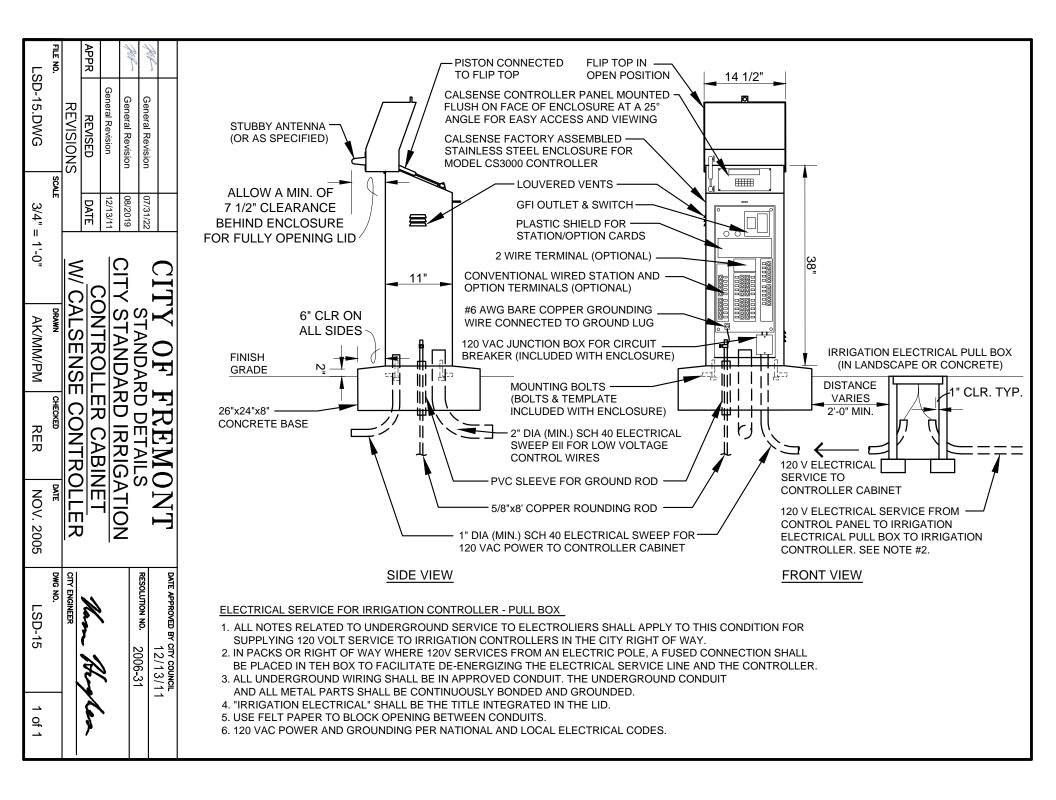1-1/4" STD. WT. A-53 E.W. BLK. STL. PIPE

NOTE:

ALL WELDED AREAS SHALL BE A MINIMUM OF 1/4 INCH BEAD **EVERY 4 INCHES**

HOLES EACH SIDE. BRACKETS CAN BE LOCATED ON SIDES OR ENDS AND SECURED

DRILL 2 - $\frac{5}{16}$ INCH WITH TAMPER PROOF BOLTS

STD. SIZES	INTERNAL DIMENSIONS	TYPE	WEIGHT
GS5	10"W x 18"H x 12"L	LIFT OFF UNIT	35
GS-1	10"W x 24"H x 22"L	LIFT OFF UNIT	40
GS-2	10"W x 24"H x 30"L	LIFT OFF UNIT	45
GS-3	10"W x 24"H x 40"L	HINGED UNIT	51
GS-4	16"W x 30"H x 46"L	HINGED UNIT	67

NOTES:

- 1. GS = POWDER-COATED STEEL GUARDSHACK OR APPROVED EQUAL.
- 2. ENCLOSURE DIMENSIONS FOR 1/2"-10" STANDARD BACKFLOW ASSEMBLIES.

NOTES:

GS-1

GS-2

GS-3

GS-3.5

GS-4

EACH END

EACH END


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SAME AS GS-2H

SAME AS GS-2H


- 1. AFTER ALL WELDING, ENTIRE UNIT SHALL BE PROCESSED WITH IRON PHOSPHATE PRE-TREATMENT. ELECTROSTATIC APPLICATION OF POWDER SHALL BE FUSION BONDED. POWDERCOAT COLOR SHALL BE BLACK.
- 2. ALL BOLTS FOR HINGES AND HASPS SHALL BE ZINC-PLATED TAMPER PROOF, EXCEPTION -USE SS HARDWARE FOR SS UNITS. SS = STAINLESS STEEL
- 3. REFER TO SPECIFICATIONS FOR MODEL NUMBER
- 4. REFER TO CITY STANDARD DETAIL LSD-14 FOR ALL MATERIALS

			CIT	CITY OF FREMONT			DATE APPROVED BY CITY COUNCI	_
Jak-	General Revision	09/09/22		STANDARD DETAILS			RESOLUTION NO. 2006-31	
Jak-	General Revision	08/2019		CITY STANDARD				
APPR	REVISED	DATE	BA	CKFLOW	Ham Highen			
, , , , , ,	REVISIONS			<u>UNIT ENCLOSURE</u>			CITY ENGINEER	
FILE NO.			= 1'-0"	AK/MM/PN	CHECKED RER	NOV. 2005	DWG NO. LSD-17	1 of 1

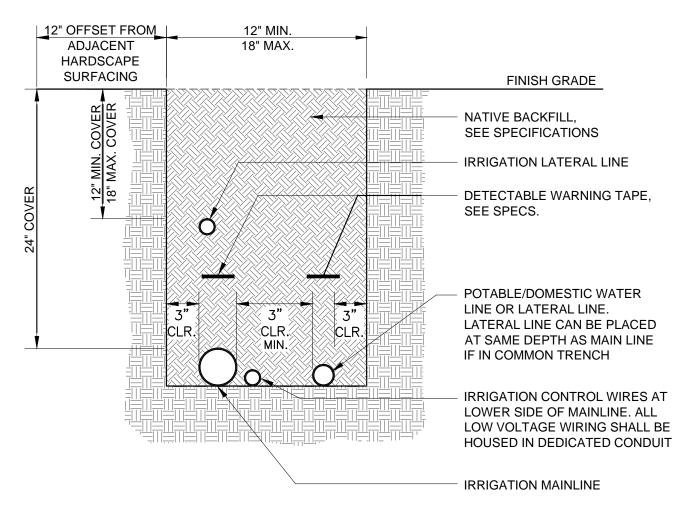

- 1. SLEEVE BELOW ALL HARDSCAPE ELEMENTS WITH CLASS 315 PVC TWICE THE DIAMETER OF THE PIPE OR WIRE CONDUIT WITHIN; BURIAL DEPTH FOR SLEEVES BELOW FINISHED GRADE ARE AS FOLLOWS:
 - 42 INCH MINIMUM UNDER THOROUGHFARE AND STREETS
 - 24 INCH MINIMUM UNDER PLANTER AREA
 - 24 INCH MINIMUM UNDER PARKING LOT
 - 18 INCH MINIMUM UNDER SIDEWALK
 - 36 INCH MINIMUM UNDER TRAFFIC CIRCLES (RESIDENTIAL AREAS)
- 2. ALL SLEEVE BELOW HARDSCAPE SHALL EXTEND 24 INCHES BEYOND HARD SURFACE EDGES.
- 3. FOR PIPE AND WIRE BURIAL DEPTHS, SEE SPECIFICATIONS, MAINLINE SHALL HAVE MINIMUM COVER OF 24 INCHES, LATERAL SHALL HAVE MINIMUM COVER OF 18 INCHES.
- 4. SCH 40 PVC FOR MAINLINE 2 INCHES OR SMALLER.
- 5. CLASS 315 PVC FOR MAINLINE 2 1/2 INCHES AND LARGER.
- 6. CLASS 200 PVC FOR 2 INCH LATERAL LINES AND SMALLER.
- SCH 40 PVC FOR QUICK COUPLING LINE 1 INCH MIN. TO 2 INCH MAXIMUM
- TRENCH BACKFILL SHALL BE NATIVE MATERIAL, COMPACT TO 90% MINIMUM, RELATIVE COMPACTION UNLESS UNDER CONCRETE OR ASPHALT. USE TRENCH BACKFILL PER CITY SPECIFICATION 11A AND 11B UNDER CONCRETE OR ASPHALT.
- 9. REFER TO DETAIL LSD-14 FOR IRRIGATION MATERIALS LIST.

RIP_			CITY	OF	FREMO	ONT	DATE APPROVED BY CITY COUN 12/13	
fer	General Revision	07/31/22	STANDARD DETAILS				RESOLUTION NO. 2006-3	1
Jak	General Revision	08/2019	CITY STANDARD			2000-0	'1	
	Council Revision	12/13/11				-		
APPR	REVISED	DATE		IRRIGATION/POTABLE			Mann He	gles
	REVISIONS		MAIN LINE TRENCH				CITY ENGINEER	
FILE NO.	:	SCALE	DRAWN		CHECKED	DATE	DWG NO.	
LS	LSD-18.DWG N.T.S.		AK	/MM/PM	RER	DEC. 2011	LSD-18	1 of 1

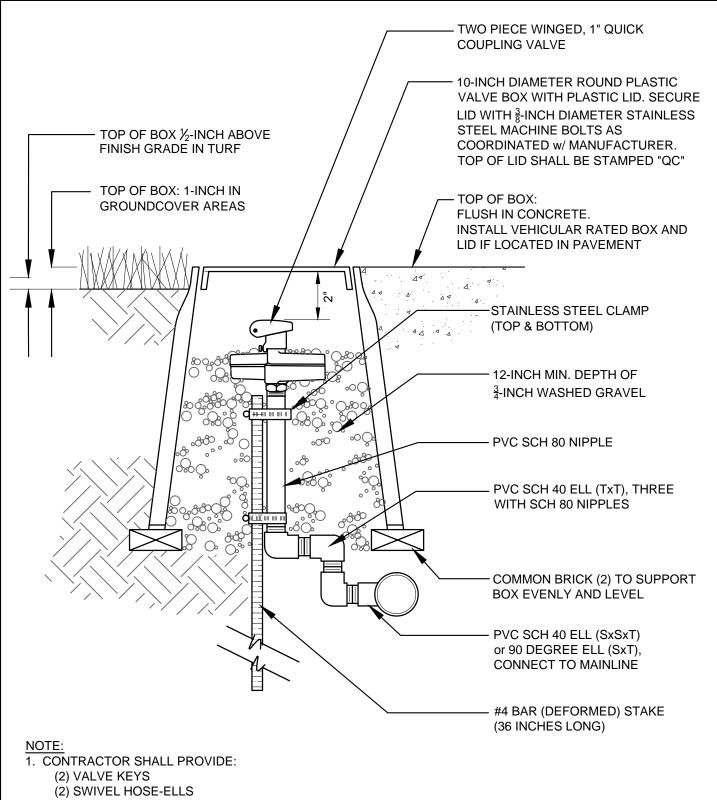

2. ALL BOXES SHALL BE OFFSET 12-INCHES FROM ANY SIDEWALK, CURB &/or HEADER

Pak	General Revision	07/31/22	CIT	Y OF	FREMO	NT	DATE APPROVED BY CITY COUNCIL	=
Jak	General Revision	08/2019				RESOLUTION NO. 2006-31	•	
	Council Revision	12/13/11				2000-31		
	General Revision	06/07/10	CITY	STANDA	RD IRRIG	ATION	1 01	,
APPR	REVISED	DATE		COUPLIN	JG \/AL\/E		Ham Hry	plea
	REVISIONS		QUICK	COUPLII	NG VALVE		CITY ENGINEER	
FILE NO.	s	CALE		DRAWN	CHECKED	DATE	DWG NO.	
LSD-19.DWG 3" =		1'-0"	AK/MM/PM	RER	DEC. 2011	LSD-19	1 of 1	

STEP 1: STRIP WIRES ½ INCH FROM ENDS.


STEP 2: APPLY SCOTCHLOK Y SPRING CONNECTOR IN A CLOCKWISE DIRECTION.






STEP 3: INSERT SPLICE FILLED TO BOTTOM OF GEL-FILLED TUBE, CHECK TO MAKE SURE CONNECTOR HAS BEEN PUSHED PAST LOCKING FINGERS AND IS SEATED AT BOTTOM OF TUBE.


STEP 4: POSITION WIRES IN WIRE CHANNELS AND CLOSE INSULATOR TUBE COVER.

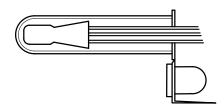

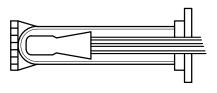

- MAXIMUM WIRE SIZES PER CONNECTOR ARE 3-#14'S OR 2-#12'S
- 2. REFER TO CITY STANDARD DETAIL LSD-14 FOR MATERIALS

			CITY OF	FREMO	ONT	DATE APPROVED BY CITY COUNCI	_
RIC			STANDAF	RD DETAILS	S	RESOLUTION NO. 2006-31	
100	General Revision	07/31/22	CITY ST	TANDARD			
Jak	General Revision	08/2019			•	-1 15	,
APPR	REVISED	DATE		<u>OLTAGE</u>	_	Mann He	plea
	REVISIONS	;	IRRIGATION WIRE SPLICE			CITY ENGINEER	
FILE NO.		SCALE	DRAWN	CHECKED	DATE	DWG NO.	
LS	LSD-20.DWG NONE		AK/MM/PM	RER	NOW. 2005	LSD-20	1 of 2

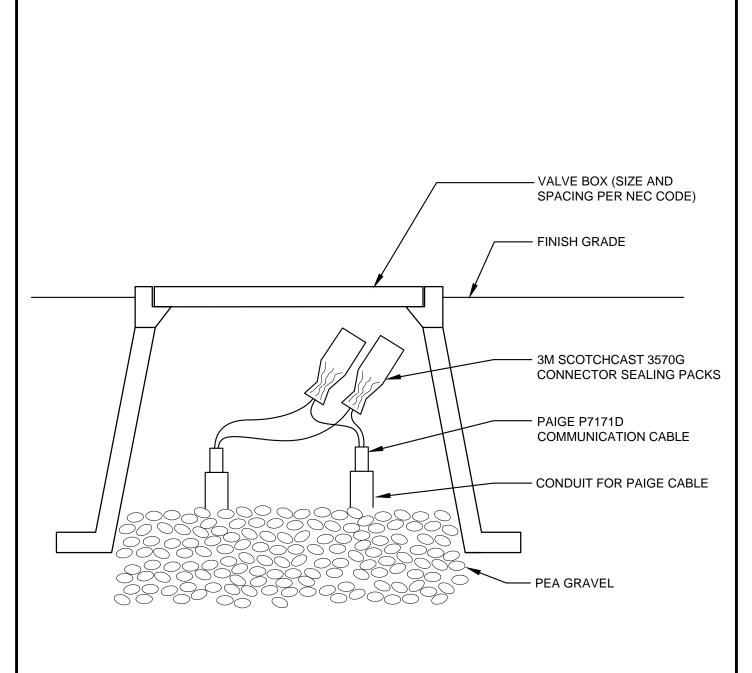

IF SPLICES ARE UNAVOIDABLE, SPLICES MUST BE COMPLETELY INSULATED FROM SOIL AND MOISTURE USING 3M SCOTCHCAST 3570G CONNECTOR SEALING PACK.

Jak	General Revision	07/31/22
Jak	General Revision	08/2019
APPR	REVISED	DATE
·	REVISIONS	

CITY OF FREMONT STANDARD DETAILS **CITY STANDARD**


PAIGE CABLE WIRE SPLICE

DATE APPROVED BY CITY COI 12/1	
RESOLUTION NO. 2006	-31

Nam Hughen


CITY ENGINEER	
DWG NO.	

CHECKED DRAWN FILE NO. SCALE LSD-20.DWG **NONE** CC **RER** AUG 2019 LSD-20 2 of 2

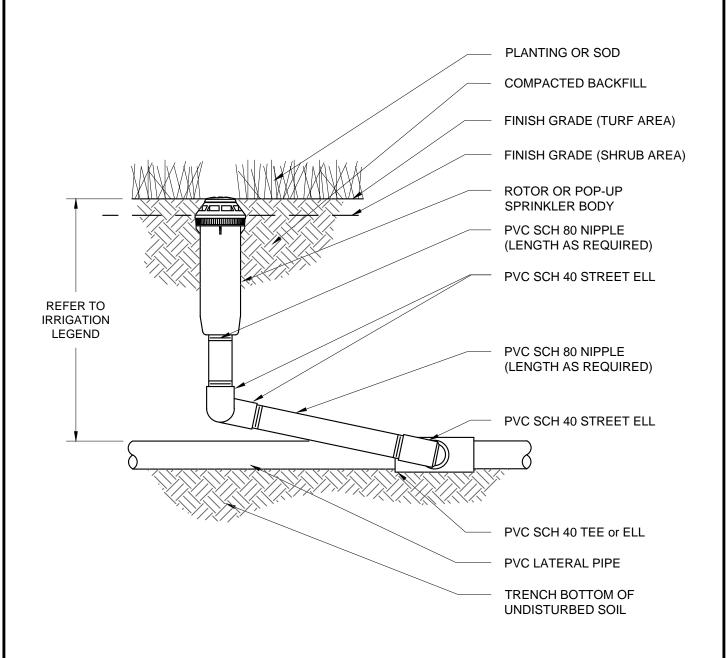


- 1. INSTALL TOP OF POP-UP SPRINKLER 1 INCH ABOVE FINISHED GRADE IN SHRUB AREAS AND FLUSH WITH FINISHED GRADE IN TURF AREAS. IN TURF FINISH GRADE IS THE TOP OF THE SOD ROOT ZONE WHEN INSTALLED. CONTRACTOR TO ACCOMMODATE FOR VARYING SOD THICKNESS, BASED ON SOD SUBMITTAL.
- 2. ROTOR SHALL BE INSTALLED FLUSH IN TURN AREAS. SEE NOTE #1.
- 3. REFER TO CITY STANDARD DETAIL LSD-14 FOR MATERIALS
- 4. INSTALL A MINIMUM OF 9" FROM EDGE OF PAVEMENT IN SHRUB AREAS AND 2" IN TURF AREAS.

			CITY OF FREMONT			DATE APPROVED BY CITY COUNCIL 12/13/1 RESOLUTION NO. 2006-31	=	
Jak	General Revision	07/31/22		OTANDAN	DEIAIL	,	2000-31	
Pak	General Revision	08/2019		CITY S	TANDARE)	1 05	,
APPR	REVISED	DATE	IDDIC			_	Nam Hry	plea
	REVISIONS			IRRIGATION ROTOR OR POP-UP			CITY ENGINEER	
FILE NO.		SCALE		DRAWN	CHECKED	DATE	DWG NO.	
LSD-21.DWG No		ONE	AK/MM/PM	RER	NOV. 2005	LSD-21	1 of 1	

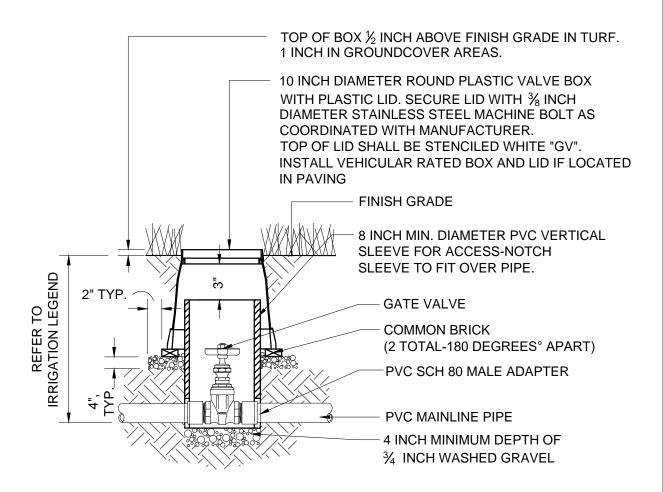


1. REFER TO CITY STANDARD DETAIL LSD-14 FOR ALL MATERIALS.


			CIT	YOF		- · -	DATE APPROVED BY CITY COUNCY 12/13/ RESOLUTION NO. 2006-31	11
Pak	General Revision	07/31/22		STANDARD DETAILS				
Pak	General Revision	08/2019		CITY ST	ANDARD			
APPR	REVISED	DATE	IDD	IRRIGATION GATE VALVE				gles
	REVISIONS			IRRIGATION GATE VALVE			CITY ENGINEER	
FILE NO.		SCALE		DRAWN	CHECKED	DATE	DWG NO.	
LSI	LSD-22.DWG 1-1/2"			AK/MM/PM	RER	NOV. 2005	LSD-22	1 of 1

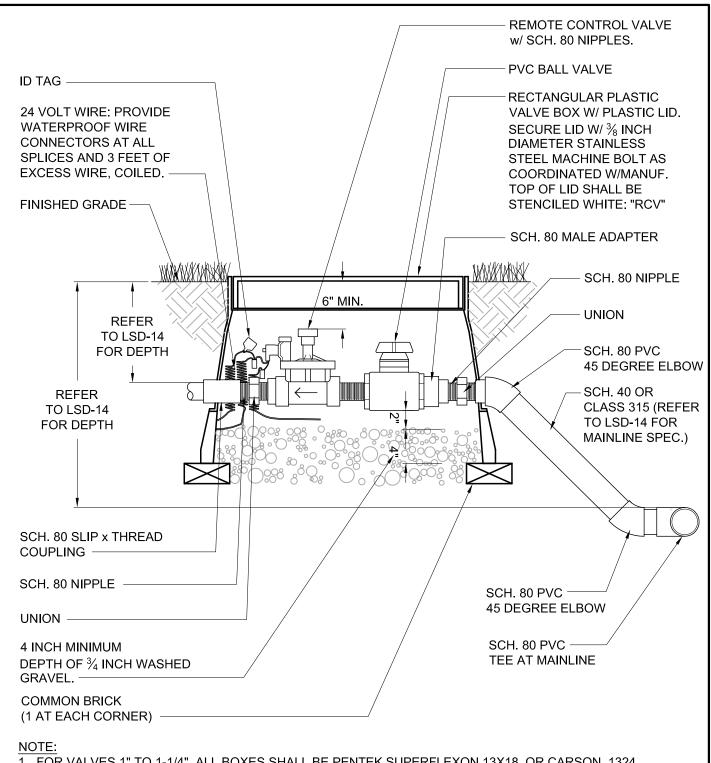

- 1. FOR VALVES 1" TO 1-1/4", ALL BOXES SHALL BE PENTEK SUPERFLEXON 13X18, OR CARSON 1324 OR APPROVED EQUAL.
- 2. FOR VALVES GREATER THAN 1-1/4", ALL BOXES SHALL BE OF CARSON PENTEK 19X25 1730-24 OR 2636 OR APPROVED EQUAL.
- 3. REFER TO CITY STANDARD DETAIL LSD-14 FOR ALL MATERIALS.


Delle -			CIT	'Y OF	FREMO	ONT	DATE APPROVED BY CITY COUNCIL 12/13/1	
Ter	General Revision	09/08/22		STANDAR	D DETAILS	3	RESOLUTION NO. 2006-31	
Pak	General Revision	07/31/22			ANDARD	_	2006-31	
Pak	General Revision	08/2019	IDDIC	TION DE	MOTE CO	MITDOI	01	,
APPR	REVISED	DATE		IRRIGATION REMOTE CONTROL VALVE W/ GATE VALVE			Ham Hy	Nes
	REVISIONS			ALVE VV/ C	JAIE VAL	<u>_VE</u>	CITY ENGINEER	
FILE NO.		SCALE		DRAWN	CHECKED	DATE	DWG NO.	
LS	LSD-23.DWG 1":		1'-0"	AK/MM/PM	RER	NOV. 2005	LSD-23	1 of 1

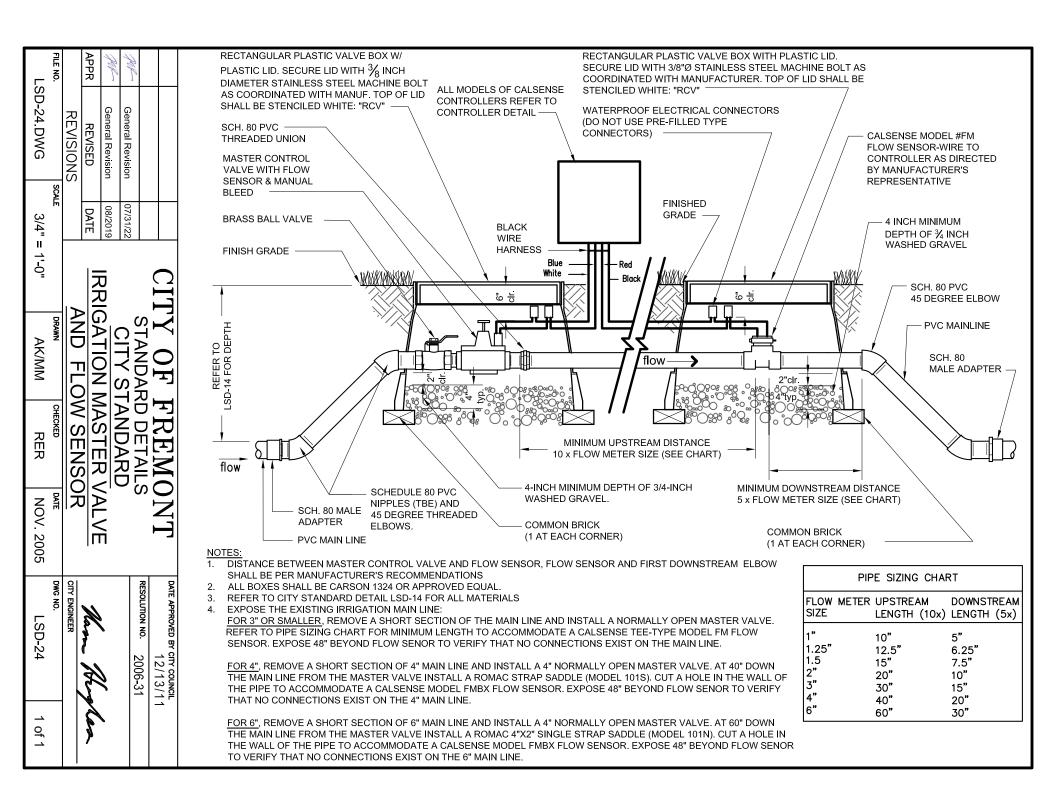

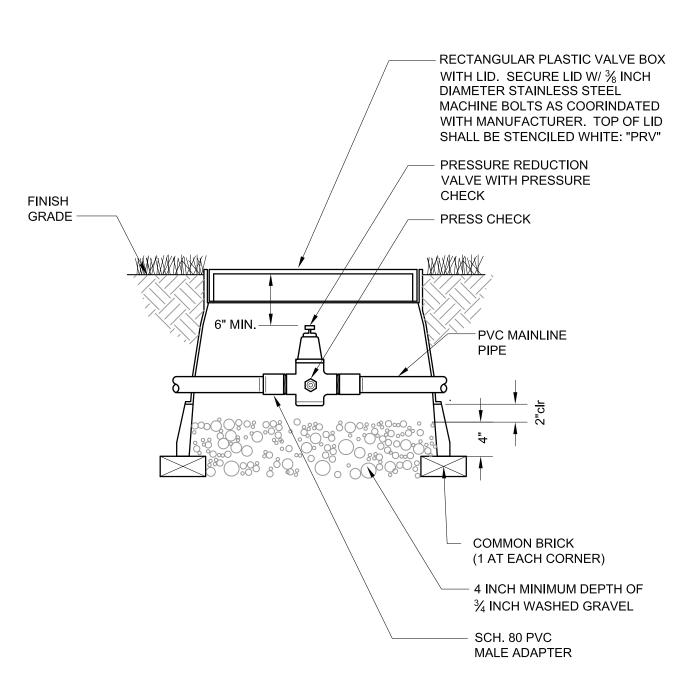

- 1. PRESSURE REDUCING VALVE BODY SHALL BE IRON; SEAT SHALL BE STAINLESS STEEL; INTEGRAL STRAINER SHALL BE STAINLESS STEEL; STEM SHALL BE BRASS; AND, DISK SHALL BE BRASS.
- 2. ALL BOXES SHALL BE PENTEK SUPERFLEXON 13X18, CARSON 1324 OR APPROVED EQUAL.
- 3. REFER TO CITY STANDARD DETAIL LSD-14 FOR ALL MATERIALS


			CITY OF FREMONT				DATE APPROVED BY CITY COUNCIL 12/13/1	1
			STANDARD DETAILS				RESOLUTION NO. 2006-3	1
				CITY ST				
			IRRIGATION PRESSURE				11 11	1.
APPR	REVISED	DATE	<u></u>				Mason Trug	res
	REVISIONS	•	REDUCTION VALVE				CITY ENGINEER	
FILE NO.		SCALE		DRAWN	CHECKED	DATE	DWG NO.	
LS	LSD-25.DWG 1" =		1'-0"	AK/MM/PM	RER	NOV. 2005	LSD-25	1 of 1

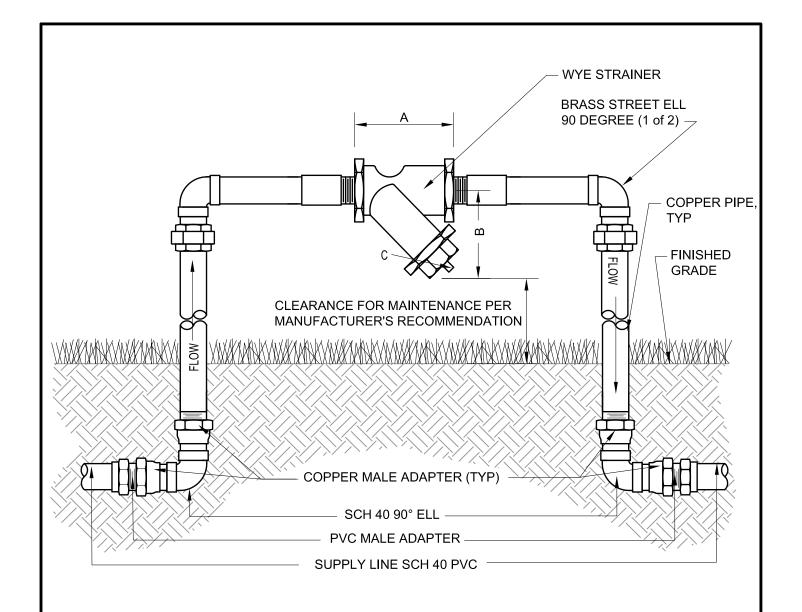



Size	1/2"	3/4"	1"	11/4"	1½"	2"
Α	2¾"	3"	3¾"	4½6"	4 ¹⁵ / ₁₆ "	61/8"
В	21/4"	2%16"	2¾"	35/8"	37/8"	51/8"
С	1/4"	3/8"	3/8"	3/4"	3/4"	1"
Wt	.75	1.38	2.13	3.13	4.5	7

- 1. BODY AND CAP SHALL BE BRONZE ASTM B62; SCREEN SHALL BE 20 MESH STAINLESS STEEL; GASKET SHALL BE NON-ASBESTOS; ENDS SHALL BE THREADED ANSI/ASME B1.20.1
- 2. WORKING PRESSURE SHALL BE NON-SHOCK, 200 PSI @ 150 DEGREES
- 3. REFER TO CITY STANDARD DETAIL LSD-14 FOR ALL MATERIALS

			CIT	CITY OF FREMONT			DATE APPROVED BY CITY COUNCIL 12/13/11		
				STANDAR	RESOLUTION NO. 2006-31				
				CITY ST	1 11 1				
APPR	REVISED	DATE	IRRI	GATION V	Nam Hughen				
	REVISIONS		HATCH WILL STRUMEN				CITY ENGINEER		
FILE NO.		SCALE		DRAWN	CHECKED	DATE	DWG NO.		
LSD-26.DWG		1" = 1'-0"		AK/MM/PM	RER	NOV. 2005	LSD-26	1 of 1	

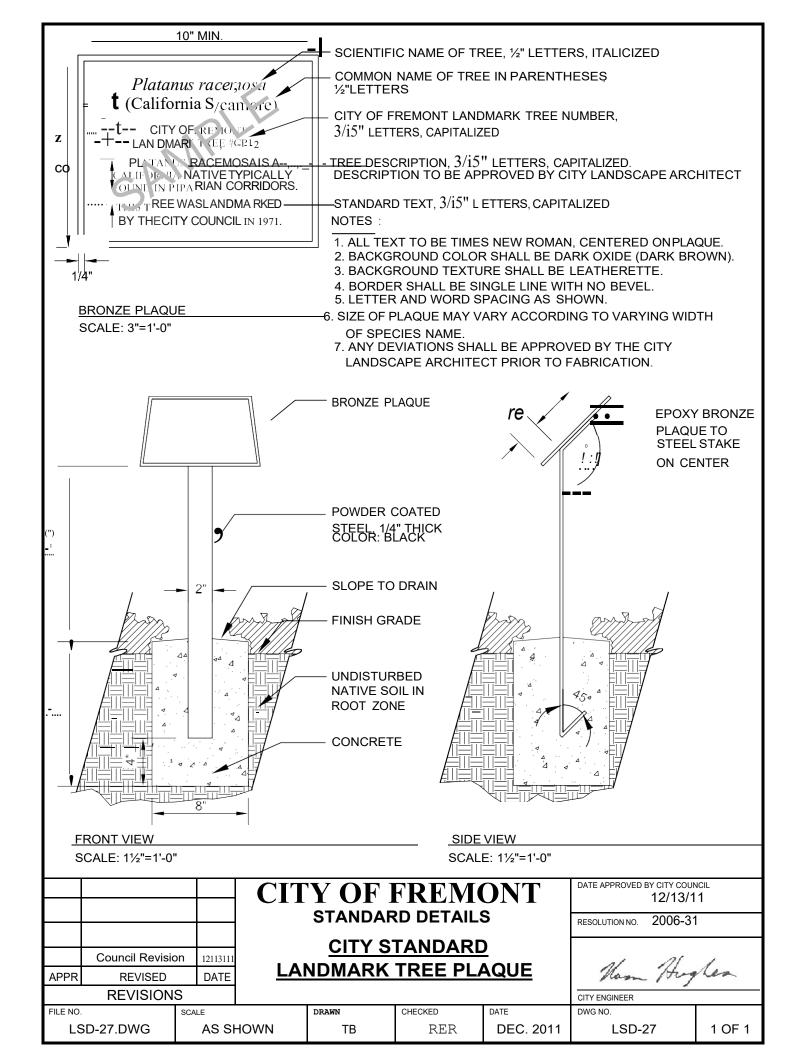

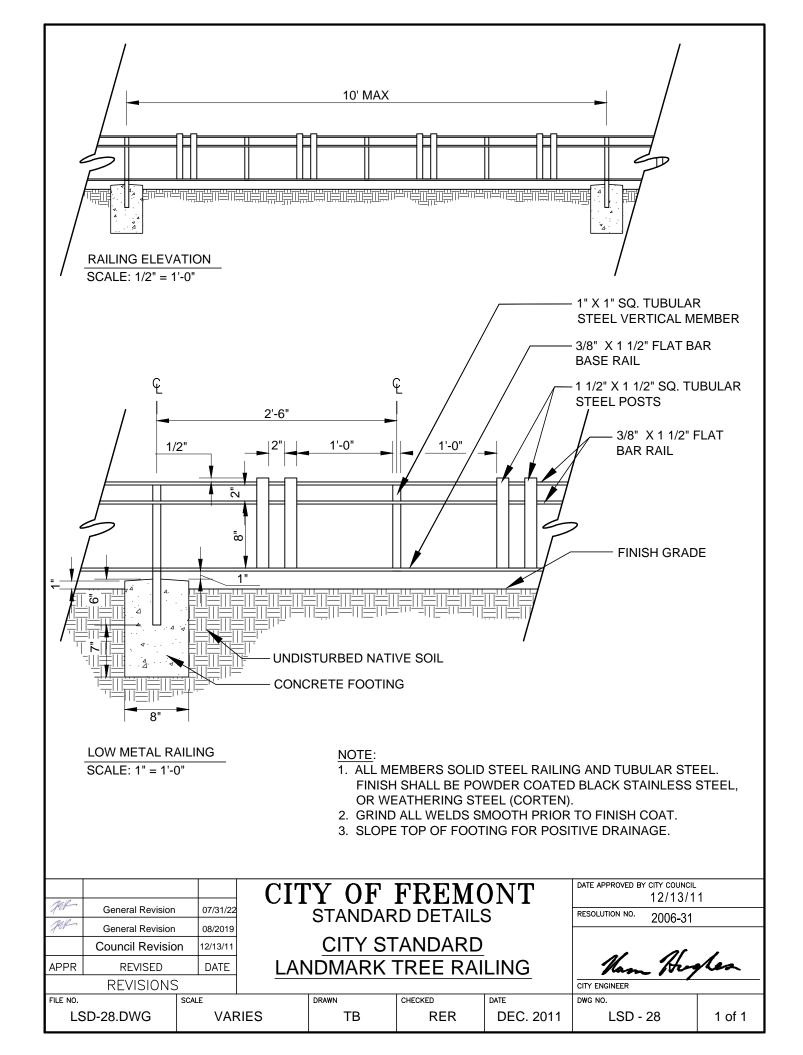

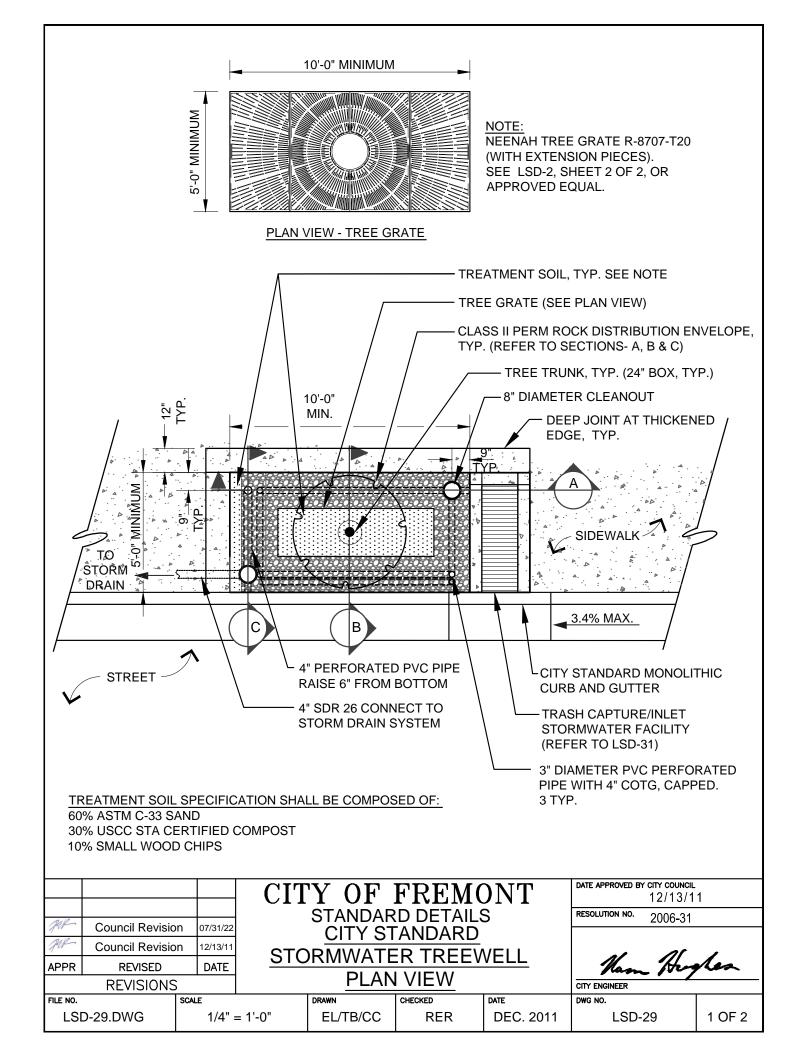

SIZING INFORMATION:

APPR

REVISED

REVISIONS


LSD-29.DWG

DATE

1/4=1'-0"

SCALE

- 1. THE MAXIMUM ALLOWABLE DRAINAGE AREA FOR THIS TREEWELL AS SHOWN (10' x 5') SHALL BE 1,250 SQ. FT. TREEWELL HAS BEEN SIZED USING THE COMBINED FLOW AND VOLUME METHODOLOGY AS DETAILED IN THE ACCWP C.3 STORMWATER TECHNICAL MANUAL. ANY DEVIATION FROM THIS SIZE (10' x 5') WOULD REQUIRE FLOW-VOLUME CALCULATIONS. SUBSURFACE TREEWELL TREATMENT DEVICES WILL NOT BE ACCEPTED USING SIMPLIFIED SIZING CRITERIA OF 4%.
- 2. THE CURB INLET OPENING OF 15" AS SHOWN IS SUFFICIENT TO CAPTURE 100% OF THE TREATMENT RUNOFF FROM THE MAXIMUM DRAINAGE AREA (1,250 SQ.FT. OF IMPERVIOUS AREA) PERTINENT TO THIS TREEWELL SIZE. THE LENGTH OF CURB OPENING REQUIRED FOR 100% CAPTURE IS DEPENDENT ON THE GUTTER SLOPE (FOR TREEWELLS INSTALLED AT GRADE). STREETS GREATER THAN 3.4% SHALL REQUIRE LONGER OR MULTIPLE CURB OPENINGS BASED ON INLET CAPTURE CALCULATIONS.

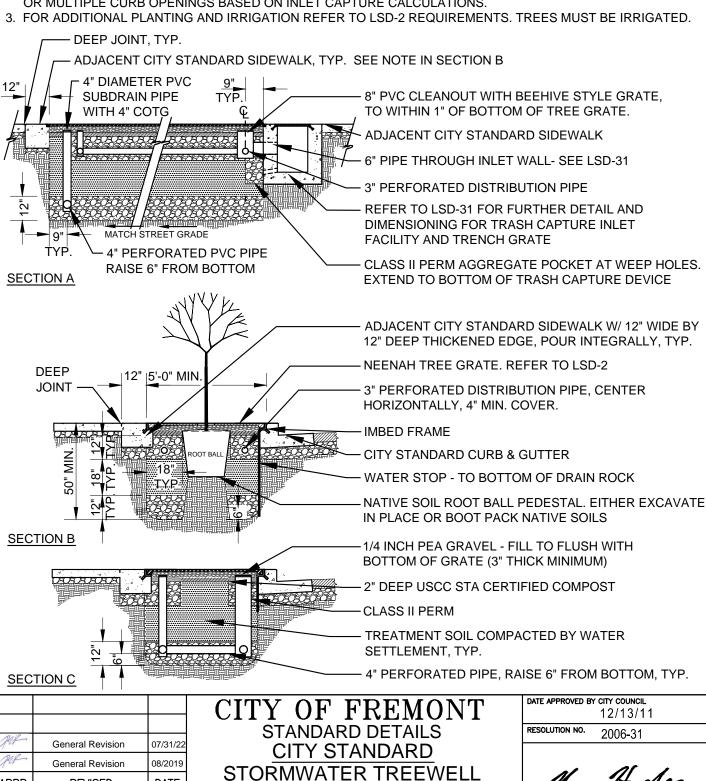

SECTIONS

CHECKED

RER

DRAWN

MAM/TB/CC


CITY ENGINEER


LSD-29


2 OF 2


DWG NO.


DEC. 2011

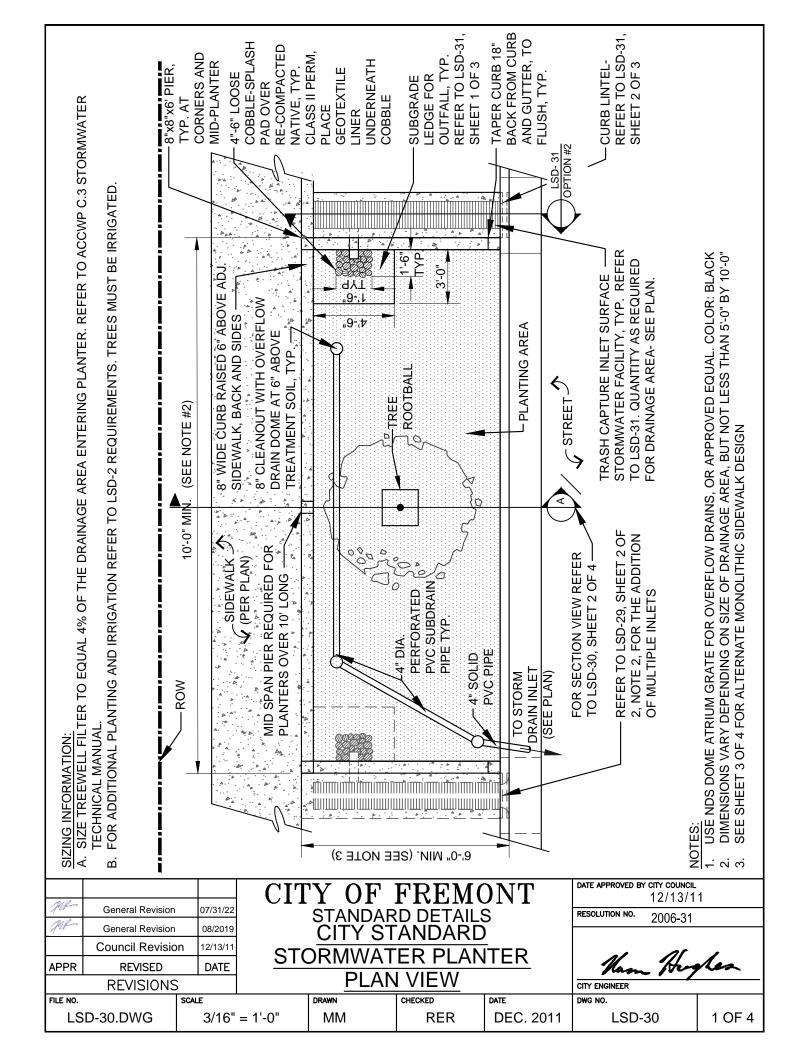


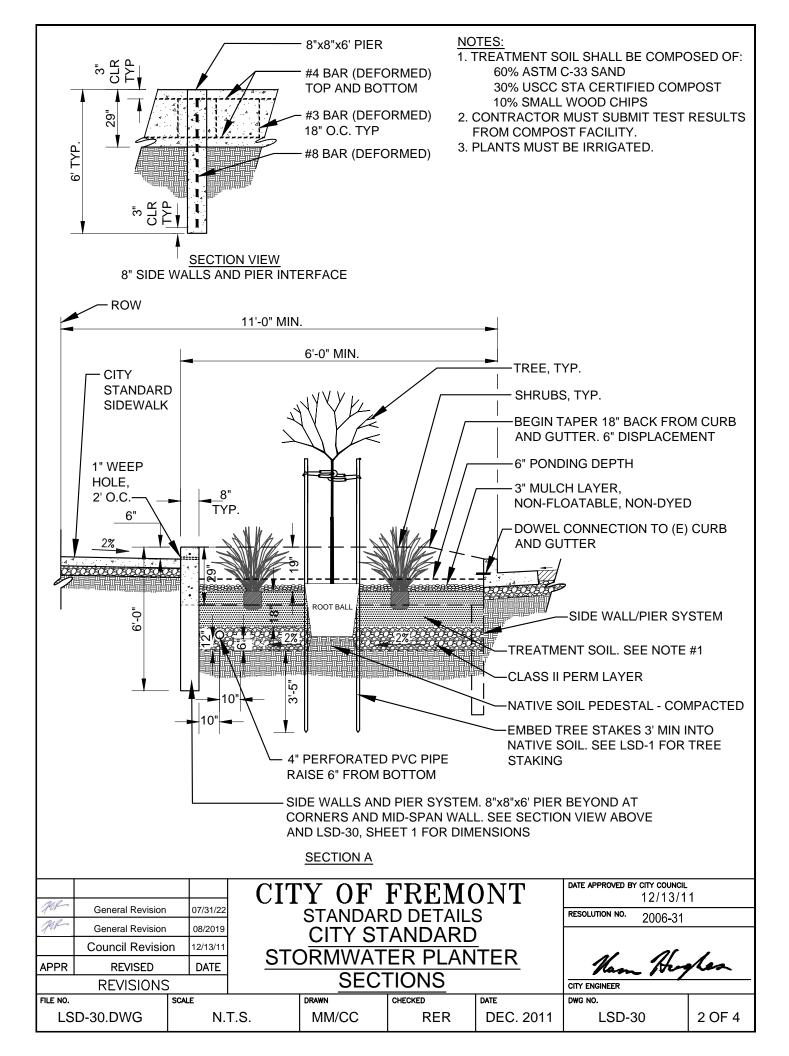


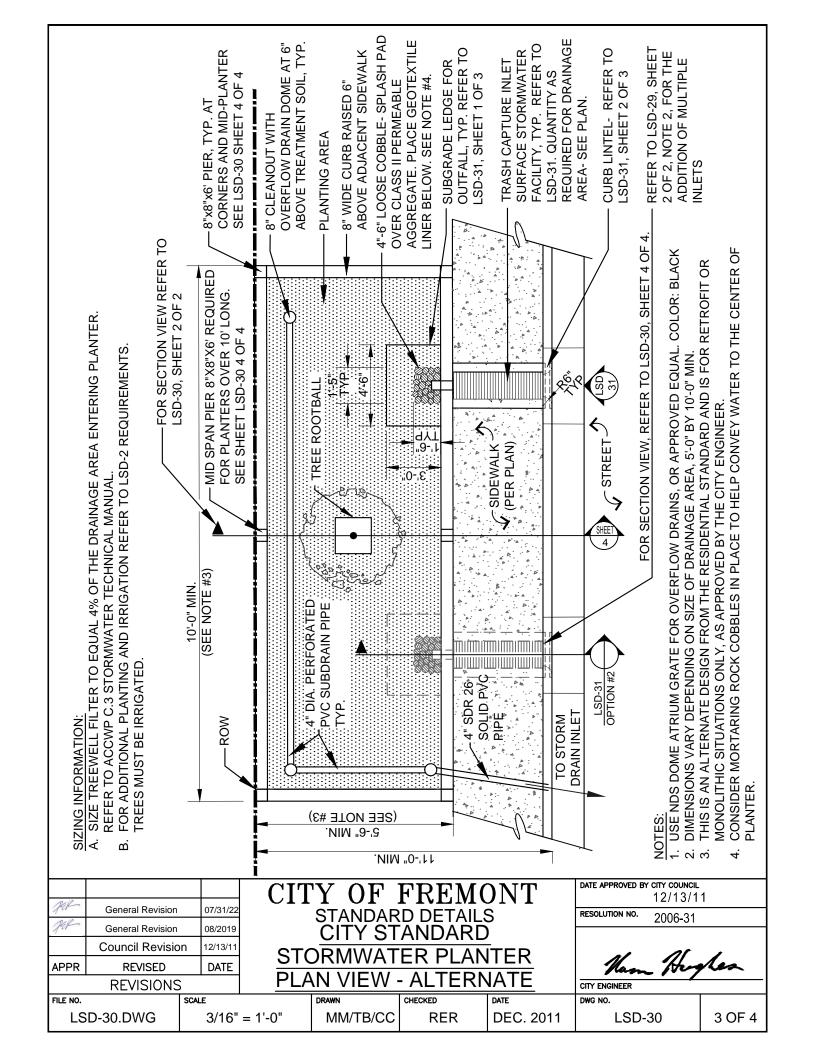

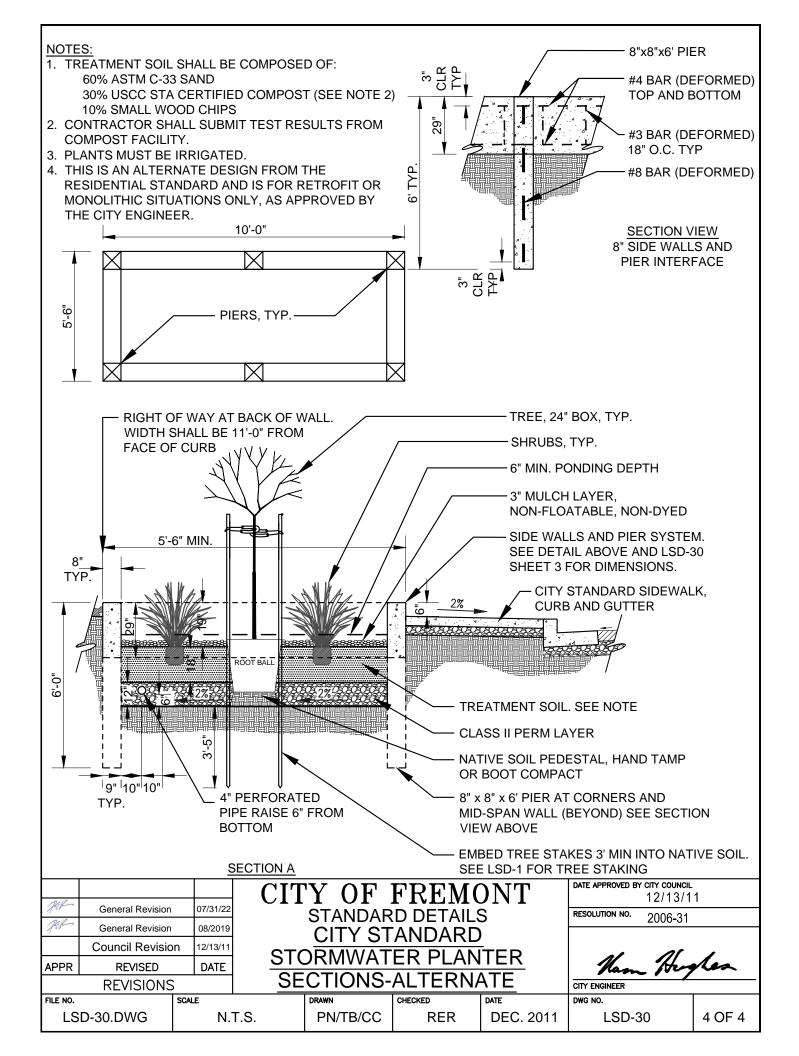

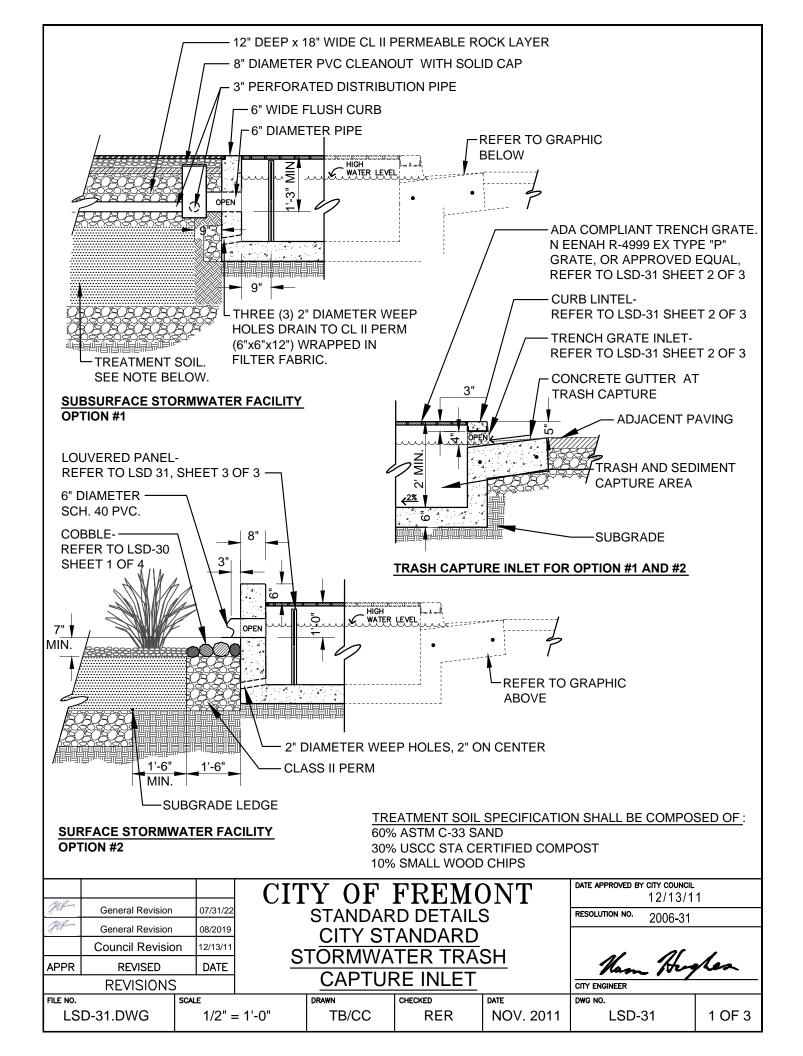


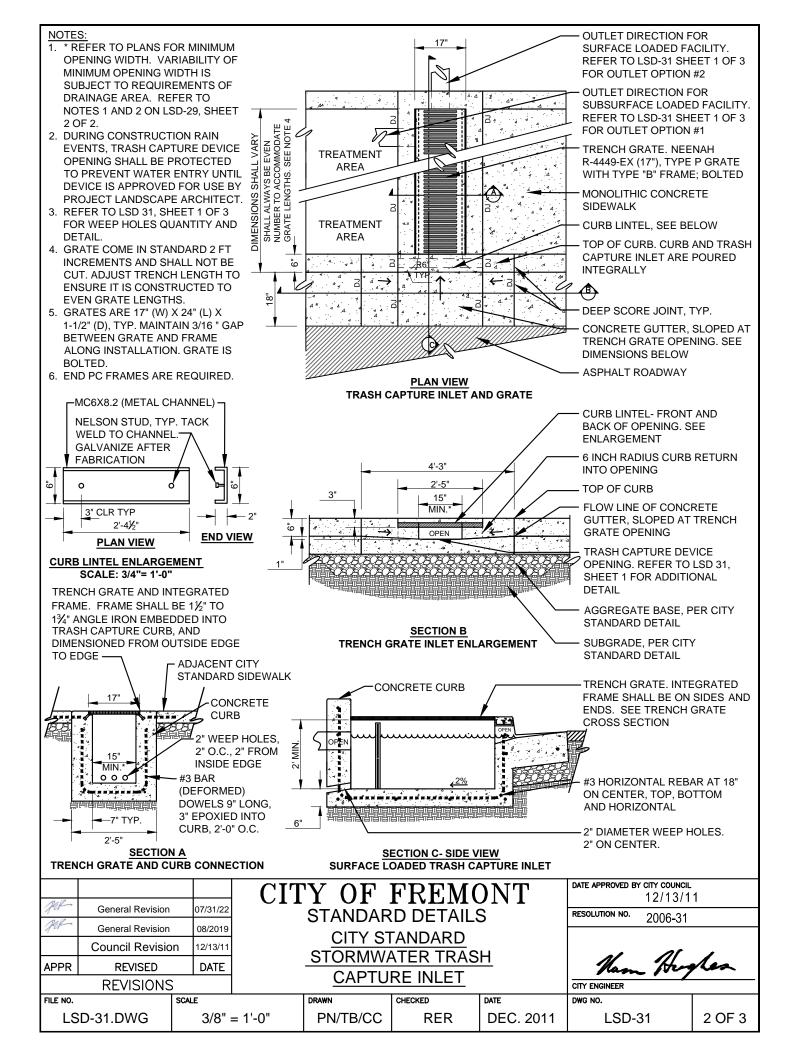

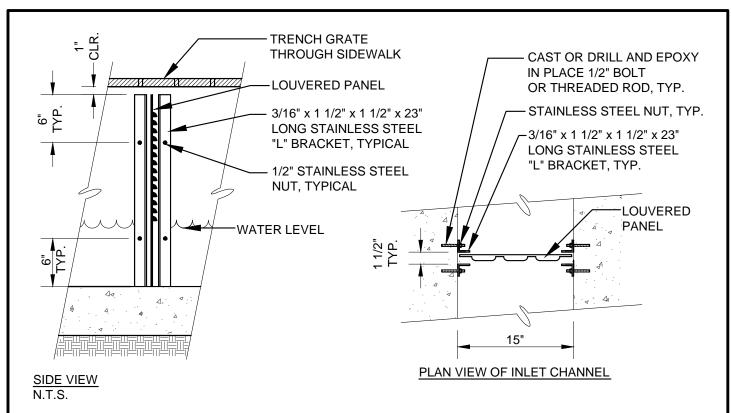

ACCEPTABLE LOUVERED PLATE AND BRACKET SUPPLIER, OR APPROVED EQUAL:

ROSCOE MOSS COMPANY TYPE 304 STAINLESS STEEL 4360 WORTH STREET LOS ANGELES, CA 90063 WWW.ROSCOEMOSS.COM

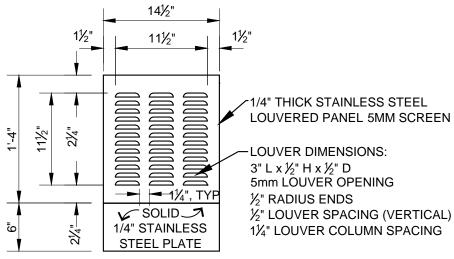

FRONT VIEW

- 1. LOUVERED PANEL MINIMUM DIMENSION: 22"H x 14 1/2"W x 1/4T". PANEL SIZES SHALL VARY DEPENDING UPON FACILITY REQUIREMENTS.
- 2. FIELD VERIFY AND MAINTAIN 1" CLEAR FROM BOTTOM OF TRENCH GRATE.

2.10			CIT	YOF	FREMO	ONT	DATE APPROVED BY CITY COUNC 12/13/	-
Jak	General Revision	07/31/22	0		D DETAILS		RESOLUTION NO. 2006-31	
Jak	General Revision	08/2019	•	CITY ST	2000-3			
	Council Revision	12/13/11	CI			-		,
APPR	REVISED	DATE	<u>5 l</u>	<u> FORMWA</u>	Ham Hogles			
REVISIONS			CAPTURE INLET				CITY ENGINEER	
FILE NO.		SCALE	C	DRAWN	CHECKED	DATE	DWG NO.	
LSD-31.DWG		1" = 1'-0"		MAM/CC	RER/MM	NOV. 2011	LSD-31	3 OF 3